




LEGEND


- INDICATES DETAIL OR PLAN NUMBER  
-INDICATES DWG SHEET NUMBER
- INDICATES ELEVATION NUMBER  
-INDICATES DWG SHEET NUMBER
- INDICATES SECTION NUMBER  
-INDICATES DWG SHEET NUMBER
- INDICATES KEY NOTE NUMBER  
(SEE KEY NOTE LEGEND, THIS SHEET)
- INDICATES ACCESSORY KEY NOTE  
(SEE LEGEND ON SHEET A3.51)
- INDICATES ELEVATION HEIGHT

KEY NOTES: ELEVATION/SECTION

- GENERAL NOTES**
- REFER TO GENERAL NOTES AS WELL AS KEY NOTES ON ARCHITECTURAL PLANS. CONTRACTOR IS RESPONSIBLE TO COORDINATE BETWEEN INFORMATION ON ALL CONTRACT DOCUMENTS INCLUDING THE ARCHITECTURAL AND ENGINEERING DRAWINGS, AND INFORMATION PROVIDED BY THE OWNER AND INTERIOR DESIGNER.
  - REFER ALSO TO FIXTURE LEGEND ON A3.51 & FINISH LEGEND ON A3.52.
  - ITEMS NOTED AS "OWNER PROVIDED" WILL BE SPECIFIED AND PURCHASED BY OWNER AND/OR INTERIOR DESIGNER. GC TO INSTALL. GC TO COORDINATE DELIVERY, INSTALLATION, AND LOGISTICS WITH OWNER.
- KEY NOTES: ELEVATION/SECTION**
- |  |  |   |  |   |
|--|--|---|--|---|
| <p>E1. ASPHALT SHINGLE (CERTAINTED LANDMARK PRO, MAX DEF MOIRE BLACK) ON SYNTHETIC UNDERLAYMENT ON 3/8" APA RATED SHEATHING. NO SUBSTITUTIONS.</p> <p>E2. CONTINUOUS RIDGE VENT, TO MATCH ROOFING FINISH.</p> <p>E3. FABRICATED SCISSOR TRUSS. 10:12 TOP CHORD, 8:12 BOTTOM CHORD. SIZE &amp; LAYOUT BY TRUSS MANUFACTURER. PROVIDE SHOP DRAWINGS PRIOR TO FABRICATION. REFER TO STRUCTURAL DRAWINGS FOR ADDITIONAL INFORMATION. COORDINATE INSTALLATION OF SCISSOR TRUSSES TO ALLOW FOR COLLAR TIE SPACING AS SHOWN ON A7.01.</p> <p>E4. ATTIC VENTILATION BAFFLE (1" MIN. DEPTH) ATTACHED TO ROOF SHEATHING ABOVE.</p> <p>E5. CLOSURE CAP. 1" RIGID INSULATION (R-5) BTWN. ROOF JOISTS &amp; ROUGH CUT AROUND RAFTER VENT. SEAL PERIMETER WITH EXPANDING FOAM SEALANT.</p> <p>E6. 1" CONTINUOUS RIGID INSULATION (R-5) OVER CONTINUOUS FULLY</p> | <p>ADHERED VAPOR BARRIER. EXTEND RIGID INSULATION TO TOP PLATE. RODENT PROTECTION CAP AT BASE.</p> <p>E7. METAL DRIP EDGE.</p> <p>E8. 6" K STYLE GUTTER, GUTTER COLOR TO MATCH TRIM.</p> <p>E9. DOWNSPOUT, 3" x 4". REFER TO PLUMBING AND CIVIL DRAWINGS.</p> <p>E10. 10.25" HIGH DENSITY "CATHEDRAL" FIBERGLASS BATT. INSULATION (R-38 MIN.)</p> <p>E11. 5.25" UNFACED HIGH DENSITY FIBERGLASS BATT INSULATION (R-21)</p> <p>E12. 2" FOIL FACED POLYISO INSULATION (R-13) FASTENED TO UNDERSIDE OF TRUSS CHORD. TAPE SEAMS</p> <p>E13. 3/8" FURRING STRIPS</p> <p>E14. 5/8" GYPSUM WALL BOARD, LEVEL 5 FINISH, PAINTED</p> <p>E15. 5/8" APA RATED SHEATHING, EA. SIDE OF 2x6 STUDS @ 16" O.C.</p> <p>E16. 5/8" APA RATED SHEATHING, EA. SIDE OF 2x8 STUDS @ 16" O.C.</p> <p>E17. SEE STRUCTURAL FOR BEAM/HEADER SCHEDULE. RIGID INSULATION BETWEEN HEADERS, WHERE APPLICABLE</p> <p>E18. PELLA IMPERVIA WINDOW. DIRECT SET, FIXED WINDOW. APPLIED GRILLES (ALUM. DS1, 5/8"), BOTH SIDES. BLACK FINISH BOTH SIDES</p> <p>E19. PELLA RESERVE COMMERCIAL ENTRY DOOR. APPLIED GRILLES AND BLACK FINISH BOTH SIDES</p> <p>E20. CONTINUOUS 2x6 TREATED PLATE WITH 3/8" DIA. ANCHOR BOLTS @ 32" O.C. SEE STRUCTURAL FOR DETAIL</p> <p>E21. CONCRETE FOUNDATION, FOOTING &amp; GEOPIERS. SEE STRUCTURAL FOR DETAIL</p> <p>E22. 3" RIGID INSULATION (R-15) CONTINUOUS AT INSIDE FACE OF FOUNDATION</p> | <p>E23. 1" ISO BOARD AT SLAB EDGE. BACKER ROD AND SEAL</p> <p>E24. EXPOSED AND FINISHED CONCRETE SLAB ON GRADE OVER 6 MIL VAPOR BARRIER (CONTINUE UNDER ENTIRE SLAB) OVER 6" GRANULAR FILL. SEE STRUCTURAL FOR SPECIFICATIONS AND DETAILS. SEE FINISH LEGEND FOR FINISH INFORMATION.</p> <p>E25. 6" AIR SPACE</p> <p>E26. FROST SLAB. SEE STRUCTURAL</p> <p>E27. SLOPE SIDEWALK 1/4":1' AWAY FROM BUILDING. MAX. 2% CROSS SLOPE. SEE CIVIL</p> <p>E28. MAINTAIN MIN. 2" CLEARANCE FROM GRADE TO FIBER CEMENT BOARD, TYP. IN ALL LOCATIONS</p> <p>E29. FIBER CEMENT VENTED SOFFIT BOARD. 1/2" x 12" SMOOTH</p> <p>E30. FIBER CEMENT TRIM BOARD. 3/4" x 3.5" SMOOTH</p> <p>E31. FIBER CEMENT TRIM BOARD. 3/4" x 5.5" SMOOTH</p> <p>E32. 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SEE FINISH LEGEND.</p> <p>E49. BUILT-IN MILLWORK. OWNER PROVIDED. COORDINATE, BLOCKING, POWER &amp; LIGHTING, CONTROLS LOCATIONS.</p> <p>E50. RECESSED WALL MOUNTED KNOXBOX MODEL 3270, DARK BRONZE</p> <p>E51. METAL GUARD &amp; STAIR HAND RAILS. PROVIDE SLEEVE/PLATE CONNECTIONS AT SUPPORT POSTS. OWNER PROVIDED. PRE-FINISHED AT SHOP. SHOP DRAWINGS TO BE PROVIDED BY VENDOR TO ARCHITECT AND GC.</p> <p>E52. SPIRAL SUPPLY DUCT. PAINT TO MATCH CEILING. SEE MECHANICAL</p> <p>E53. 2x6 OUTLOOKERS @ 24" O.C. SEE STRUCTURAL</p> <p>E54. SIMPSON TIE. SEE STRUCTURAL</p> <p>E55. 2x10 WOOD RAFTERS @ 16" O.C. SEE STRUCTURAL</p> <p>E56. 2x8 WOOD JOISTS @ 16" O.C.</p> <p>E57. 6x6 TREATED WOOD POSTS. SIMPSON POST CAP AND BASE, TYP.</p> <p>E58. 3/4" PLYWOOD SUB-FLOOR ON 2x12 WOOD JOISTS @ 16" O.C., DBL EVERY OTHER. SEE STRUCTURAL</p> <p>E59. RESILIENT CHANNELS @ 16" O.C. AT RIGHT ANGLE TO JOISTS. TYPE SW SCREW ATTACHMENTS TO JOISTS</p> <p>E60. 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EXTERIOR METAL BUILDING SIGN, INTERNALLY HALO LIT. INDIVIDUALLY MOUNTED PAINTED ALUMINUM LETTERS. EXTERIOR SIGNAGE WILL BE SUBMITTED SEPARATELY TO THE CITY OF HUDSON FOR APPROVAL. INSTALLATION TO OCCUR AS PART OF CONSTRUCTION.</p> |
|--|--|---|--|---|

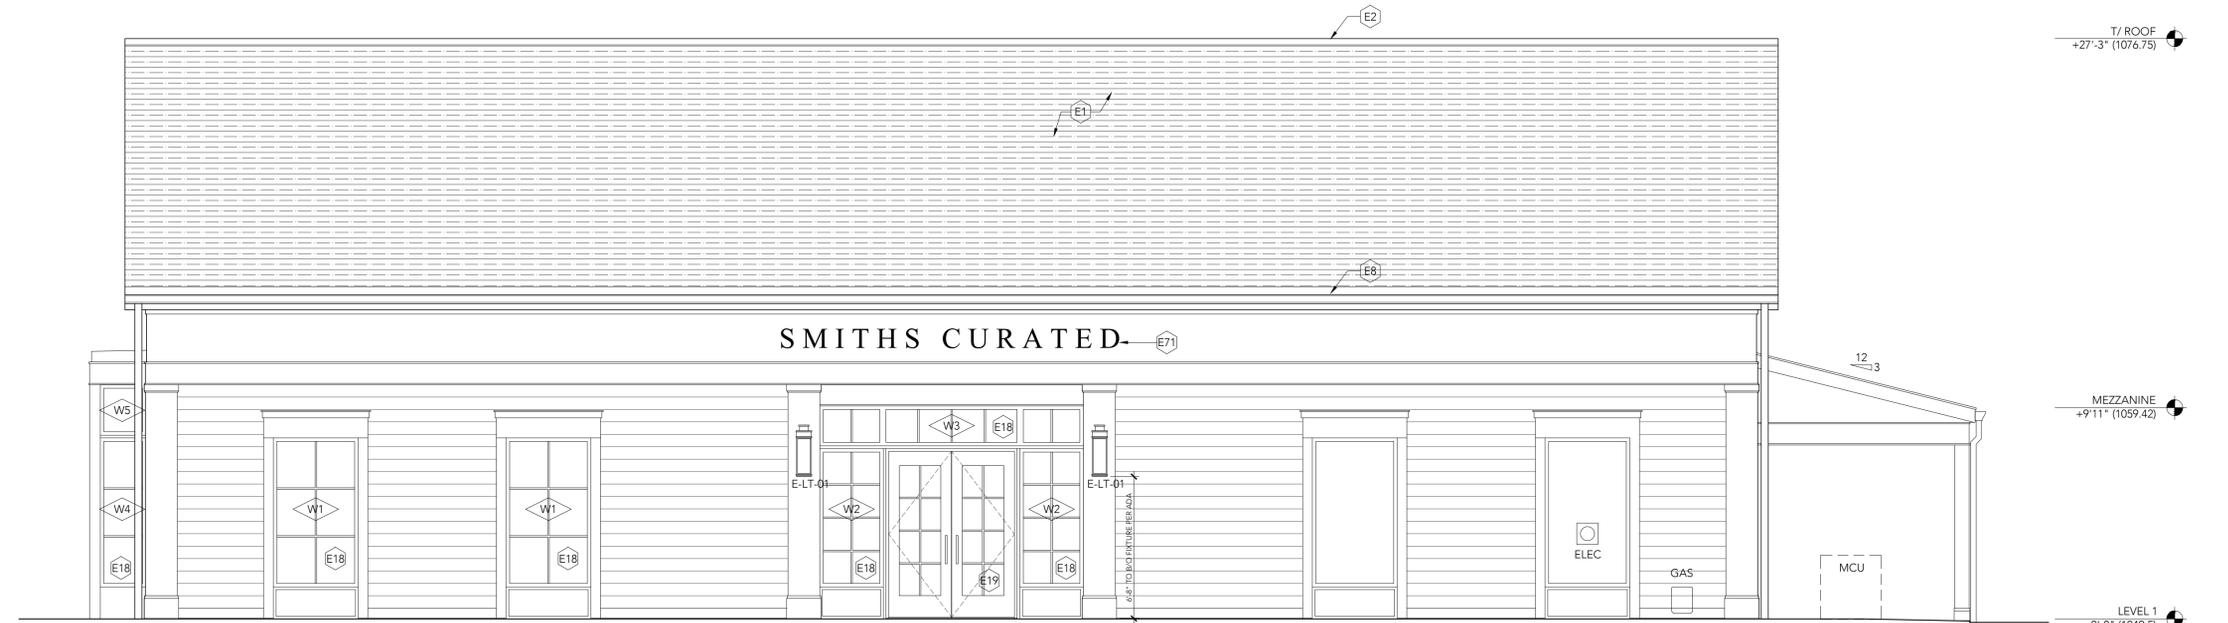

2 EXTERIOR ELEVATION SOUTH (PARKING LOT)  
SCALE: 1/4" = 1'-0"

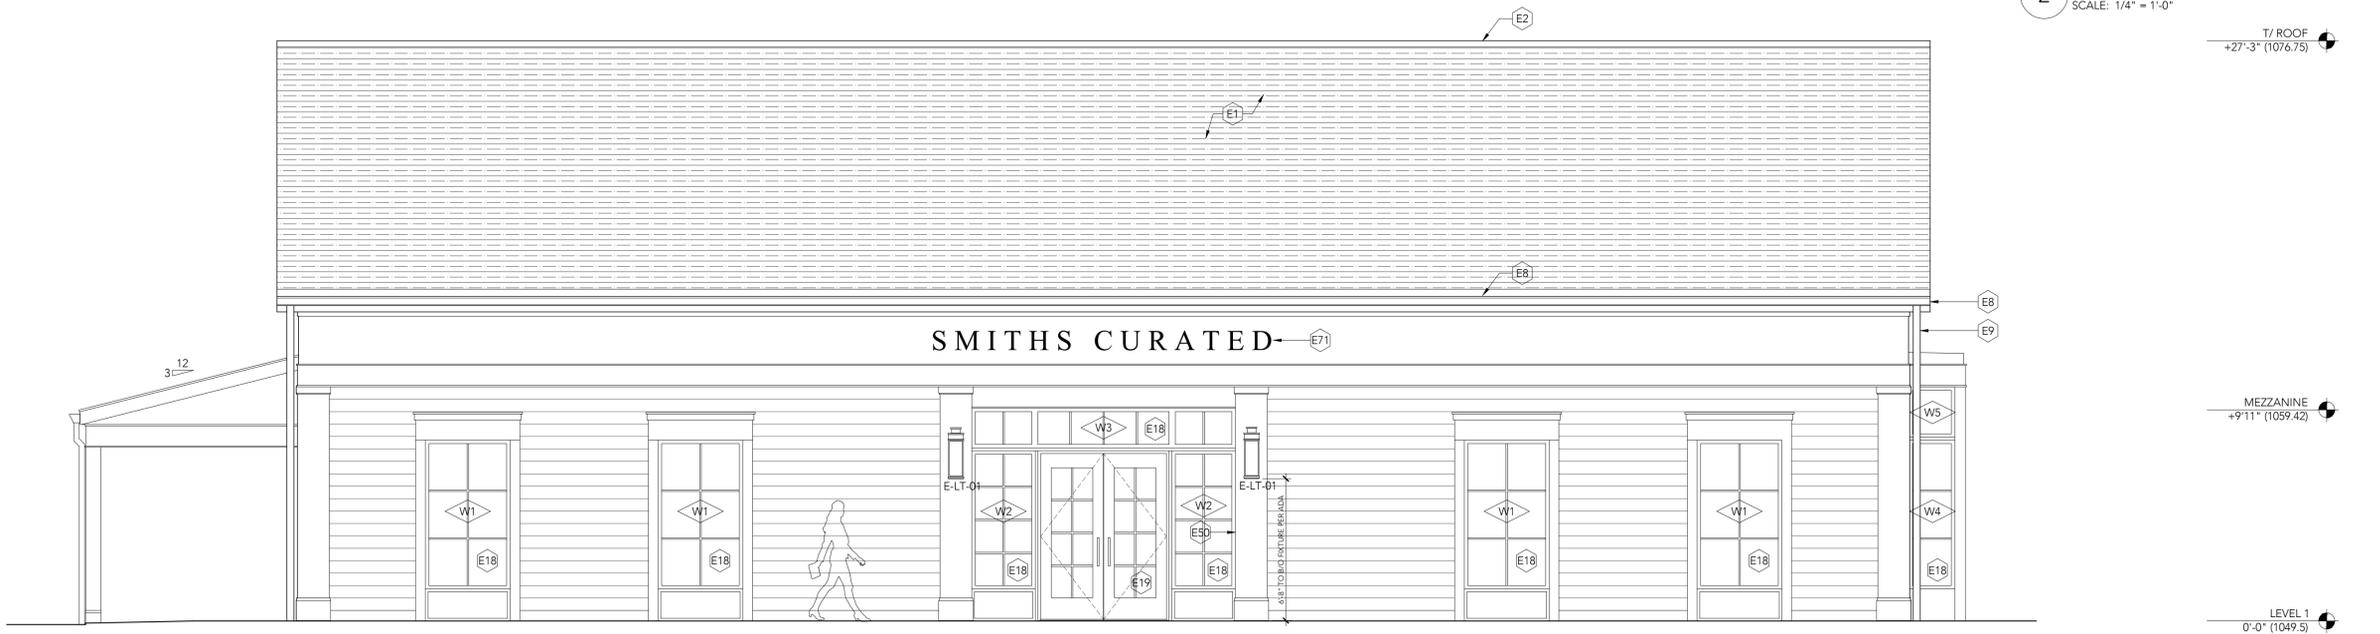

1 EXTERIOR ELEVATION NORTH (CLINTON ST.)  
SCALE: 1/4" = 1'-0"




PROJECT INFORMATION

PROPOSED NEW CONSTRUCTION:  
**SMITHS CURATED BLDG.**  
48 CLINTON STREET  
HUDSON, OH 44236

ISSUED FOR PERMIT / BID

GA PROJECT NO. 2020.013

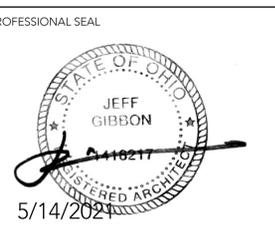

DATE: JEFFREY W GIBBON OH LICENSE: ARC.1416217 EXPIRATION 12/31/2021

DATE	TITLE
2021-0514	PERMIT / BID SET

NO.	DATE	DESCRIPTION

SHEET DATE: 05/14/2021  
ISSUED FOR PERMIT / BID

SHEET TITLE:  
**CONSTRUCTION BUILDING ELEVATIONS**

SHEET NO.  
**A3.00**

LEGEND

-  -INDICATES DETAIL OR PLAN NUMBER  
-INDICATES DWG SHEET NUMBER
-  -INDICATES ELEVATION NUMBER  
-INDICATES DWG SHEET NUMBER
-  -INDICATES SECTION NUMBER  
-INDICATES DWG SHEET NUMBER
-  -INDICATES KEY NOTE NUMBER  
(SEE KEY NOTE LEGEND, THIS SHEET)
-  -INDICATES ACCESSORY KEY NOTE  
(SEE LEGEND ON SHEET A3.51)
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|--|--|---|--|--|

**GIBBON**  
ARCHITECTURE  
3012 chadbourne road shaker, oh 44120  
216.385.5793

**SMITHS**  
CURATED

PROJECT INFORMATION

PROPOSED NEW CONSTRUCTION:

**SMITHS CURATED BLDG.**  
48 CLINTON STREET  
HUDSON, OH 44236

ISSUED FOR PERMIT / BID

GA PROJECT NO. 2020.013

PROFESSIONAL SEAL



DATE: \_\_\_\_\_  
JEFFREY W GIBBON OH LICENSE: ARC.1416217  
EXPIRATION 12/31/2021


REVISION SCHEDULE



NO.	DATE	DESCRIPTION

SHEET DATE: 05/14/2021  
ISSUED FOR PERMIT / BID

SHEET TITLE:  
**CONSTRUCTION  
BUILDING ELEVATIONS**


SHEET NO.  
**A3.01**

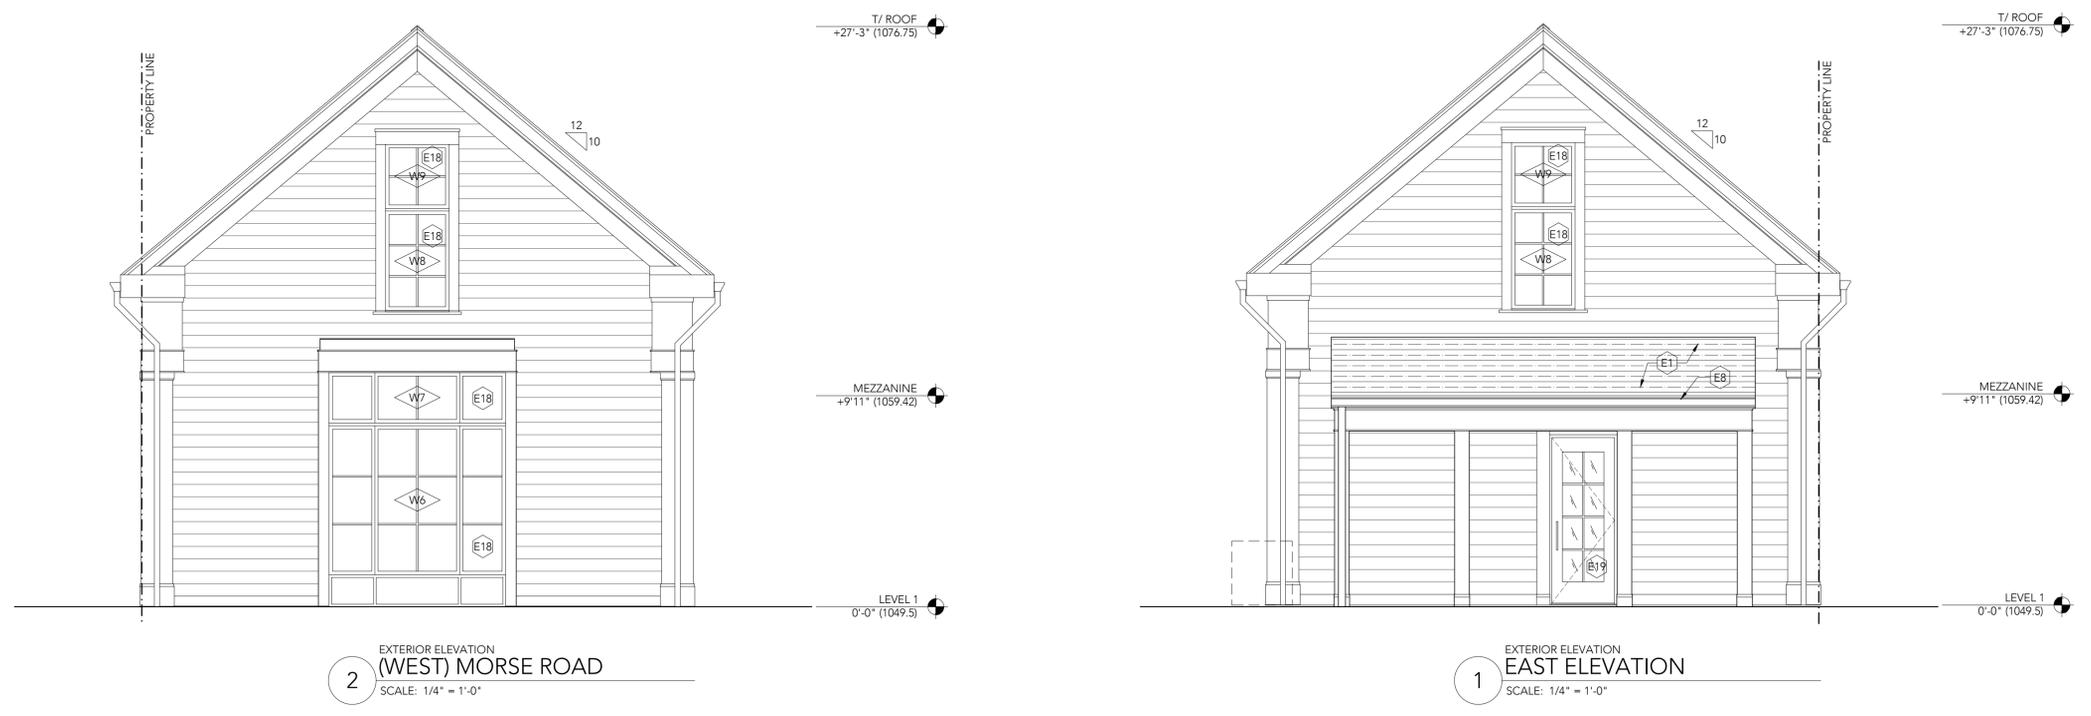

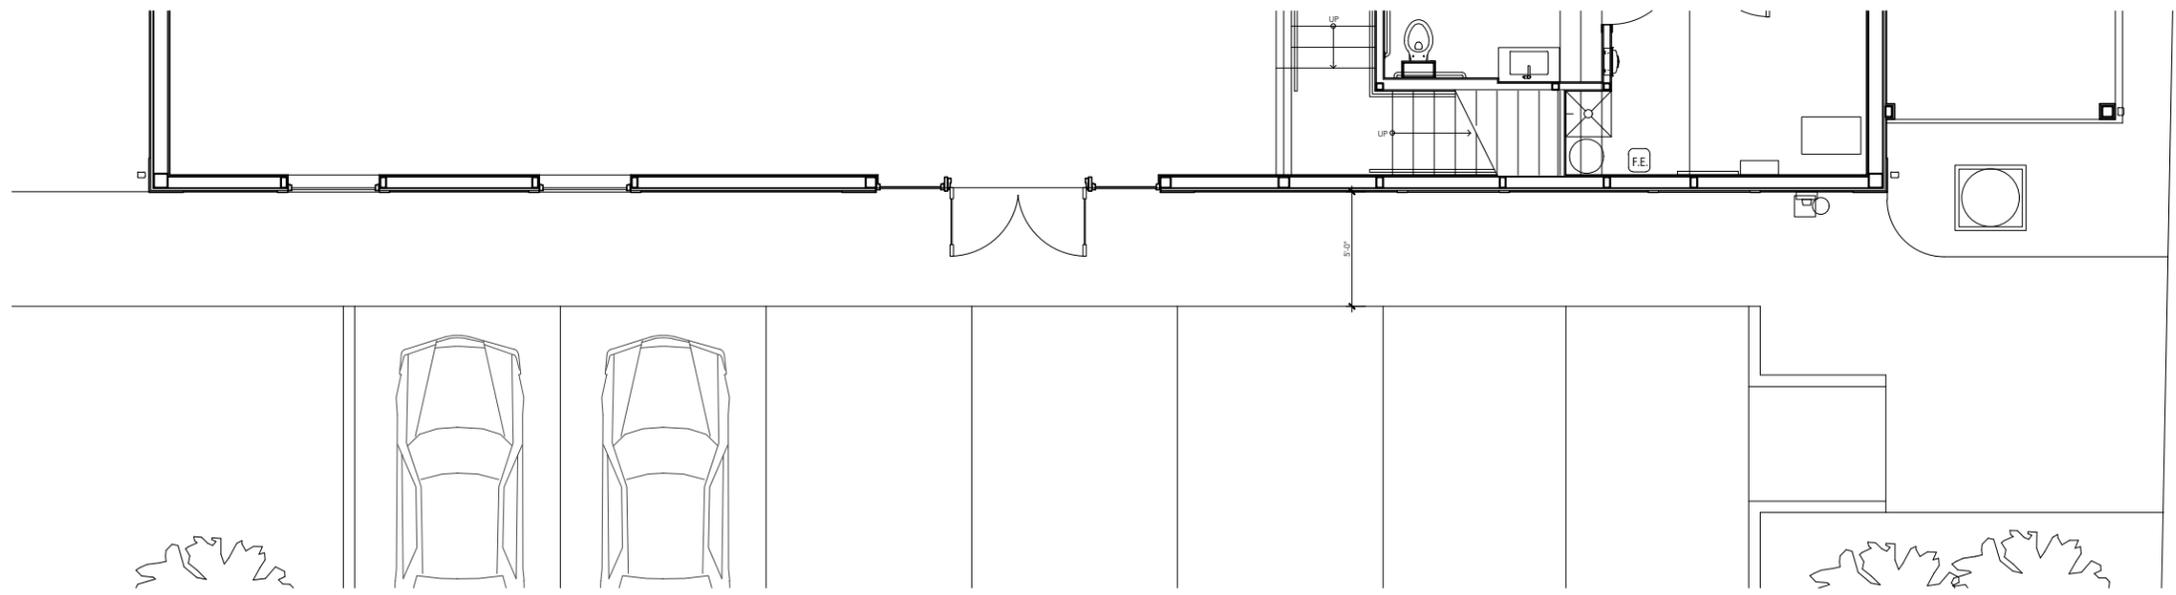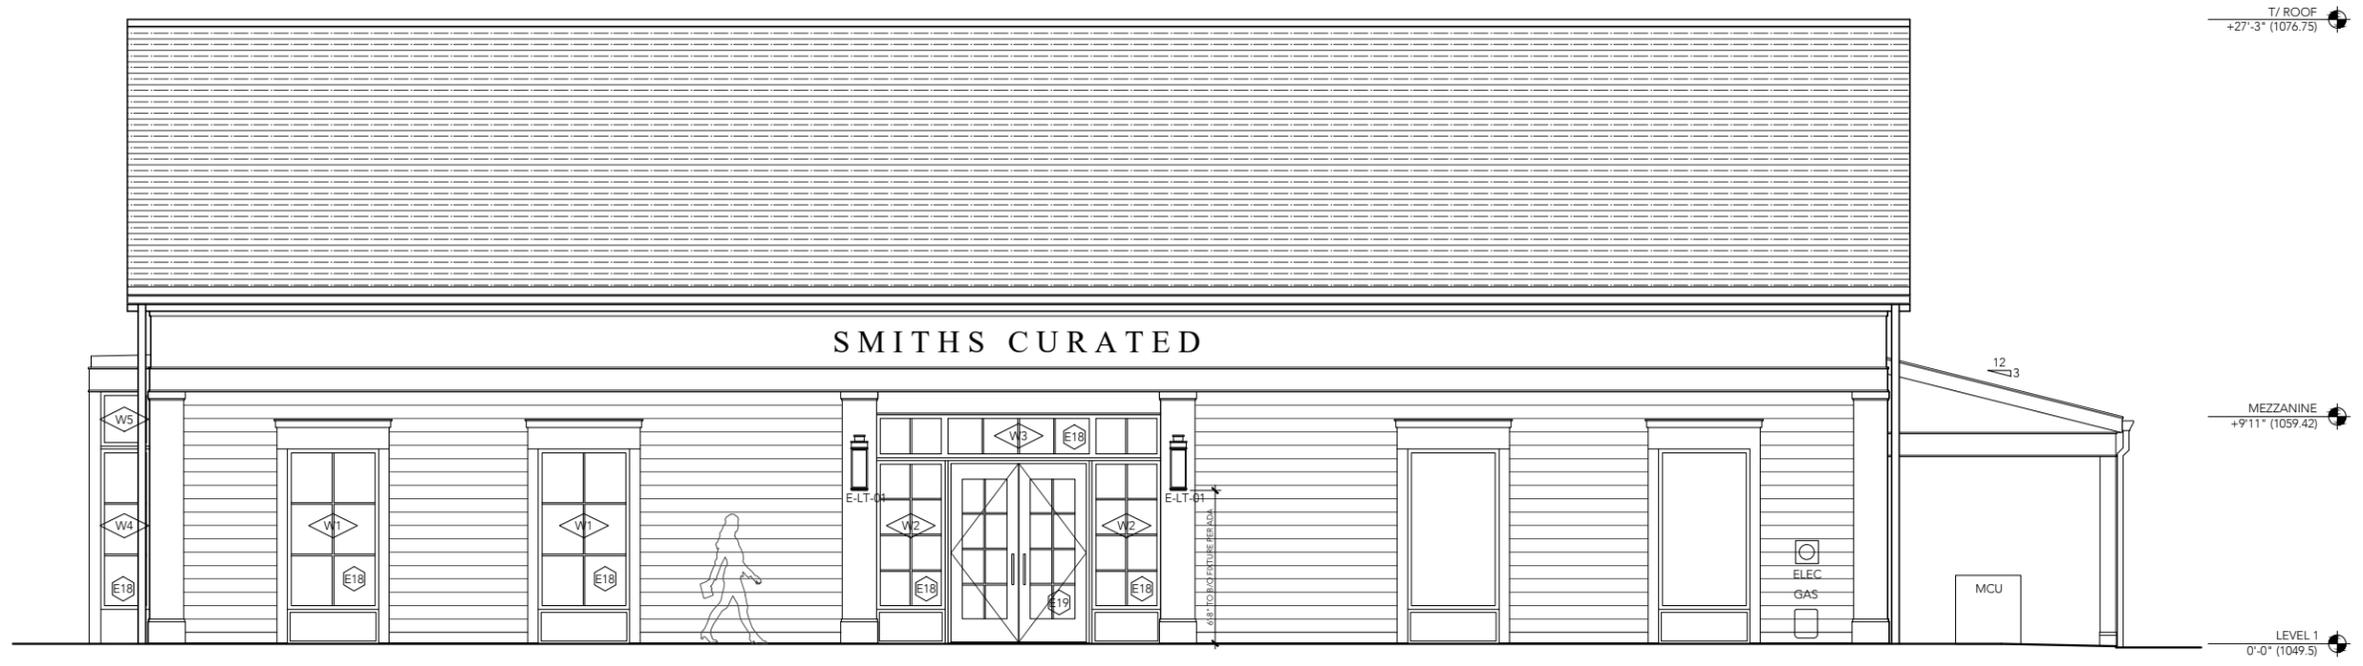



PRECEDENT IMAGES

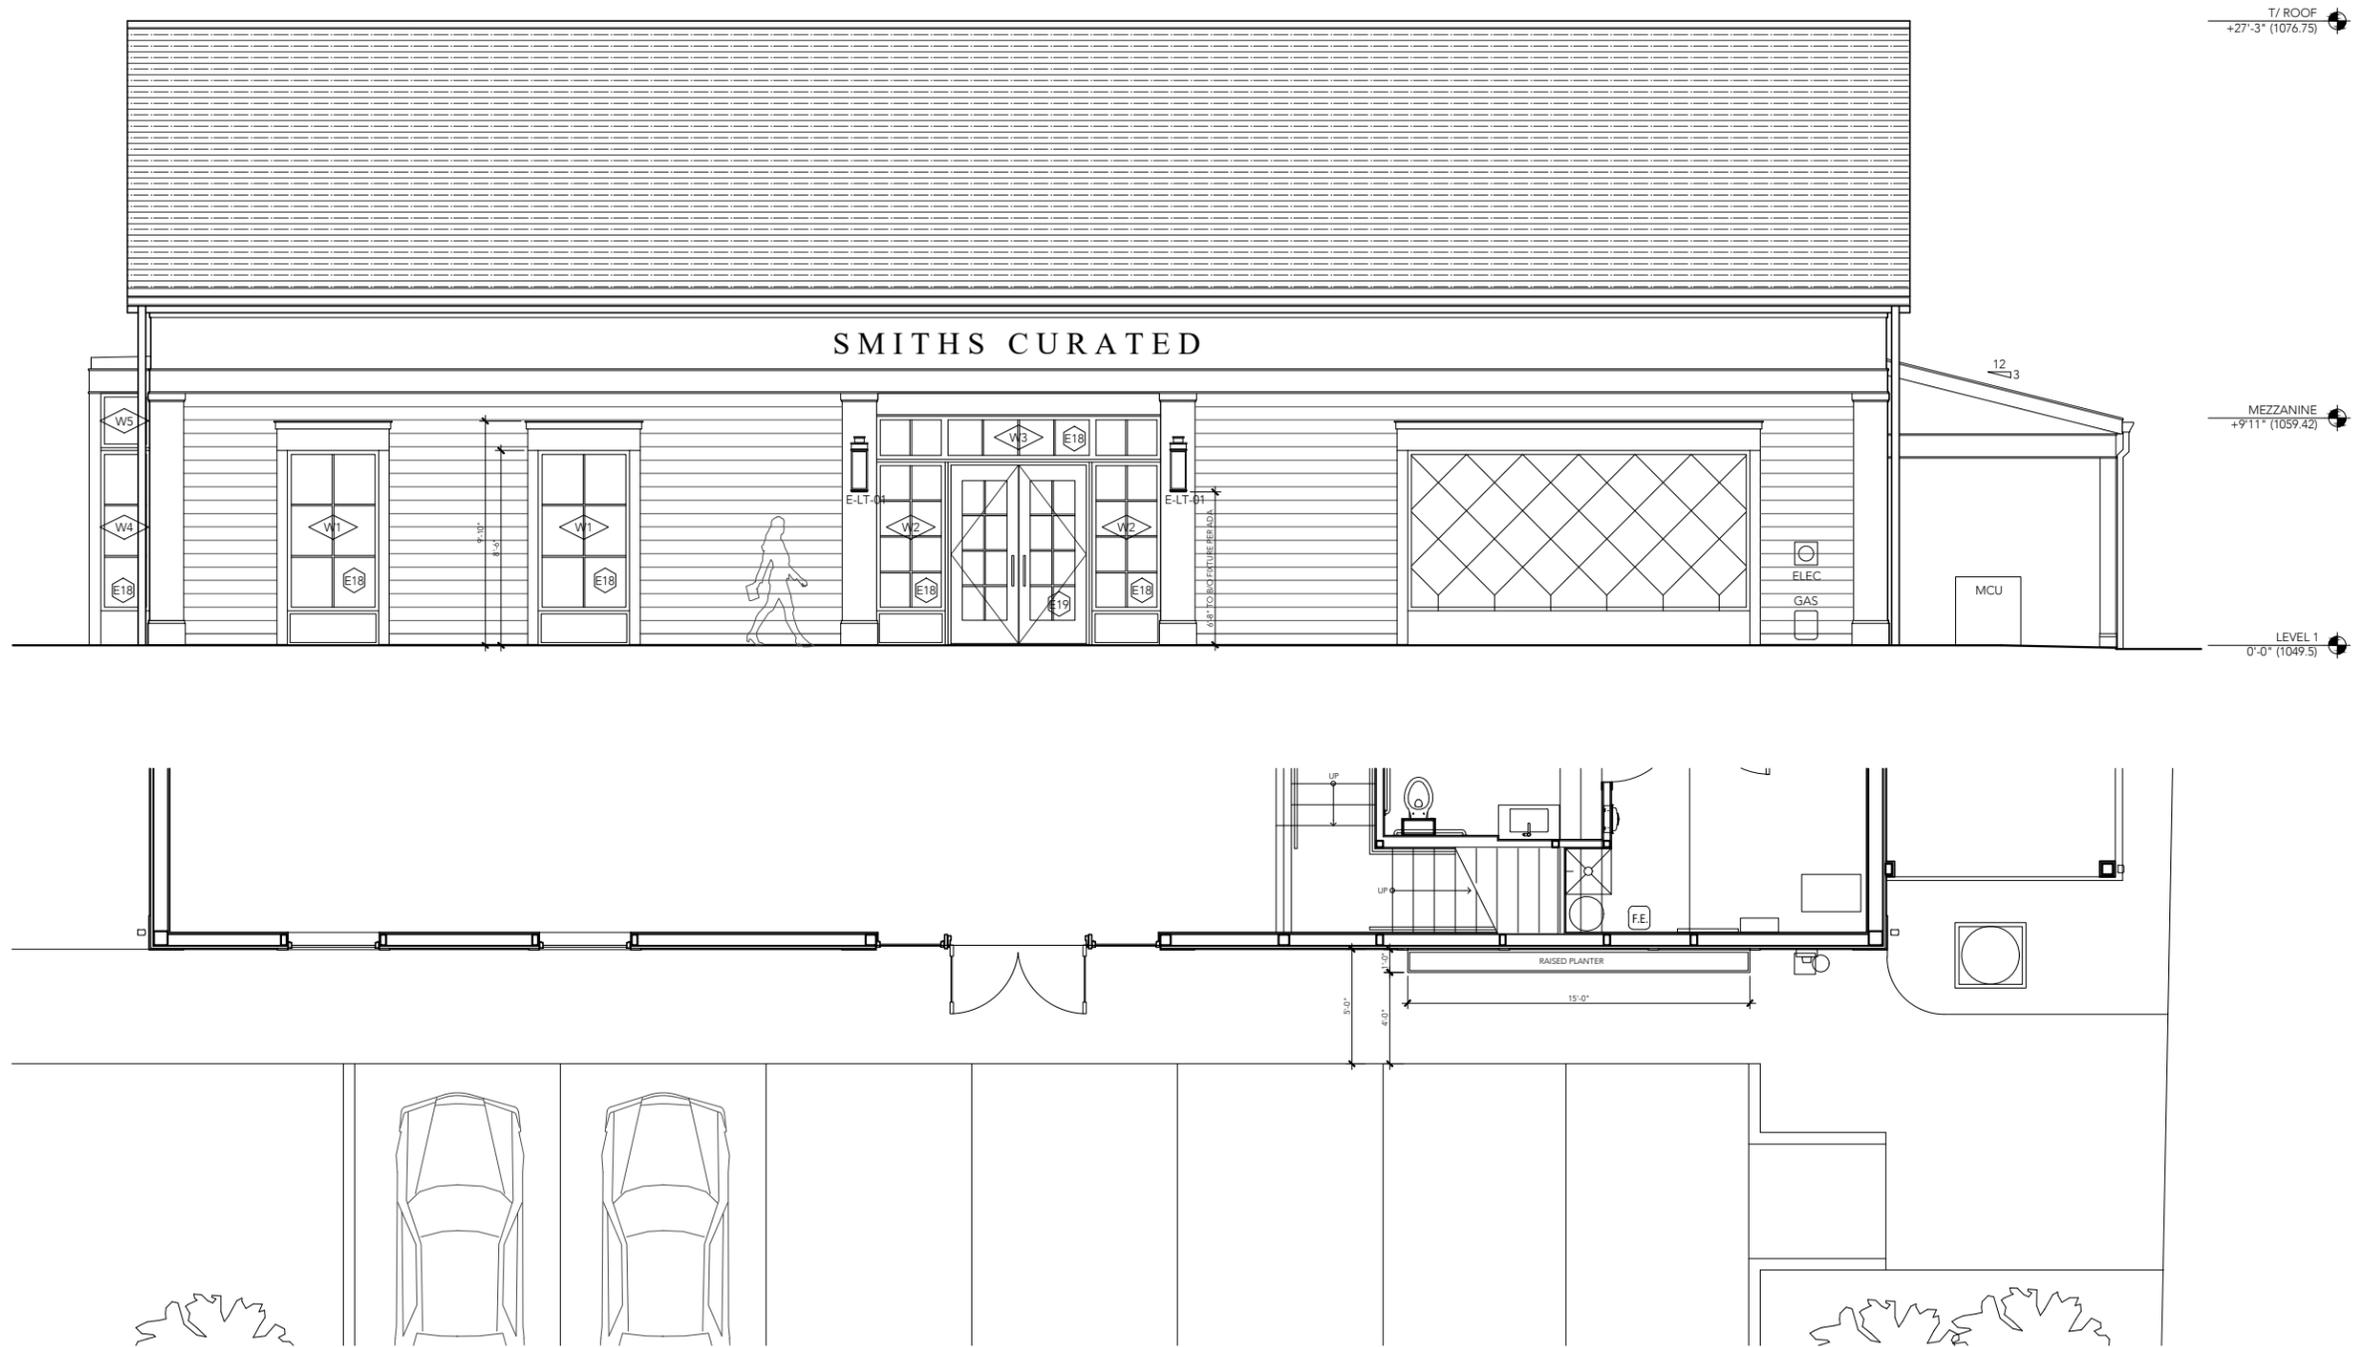

**48 CLINTON STREET**  
HUDSON AHBR, SUPPLEMENTAL INFORMATION



48 Clinton Street, Hudson, OH | Smiths Curated Building  
© 2021 Gibbon Architecture


**JASMINE ESPALIER OPTION**  
SOUTH ELEVATION OPTIONS

SCALE: 1/8" = 1'-0"

JUNE 9, 2021



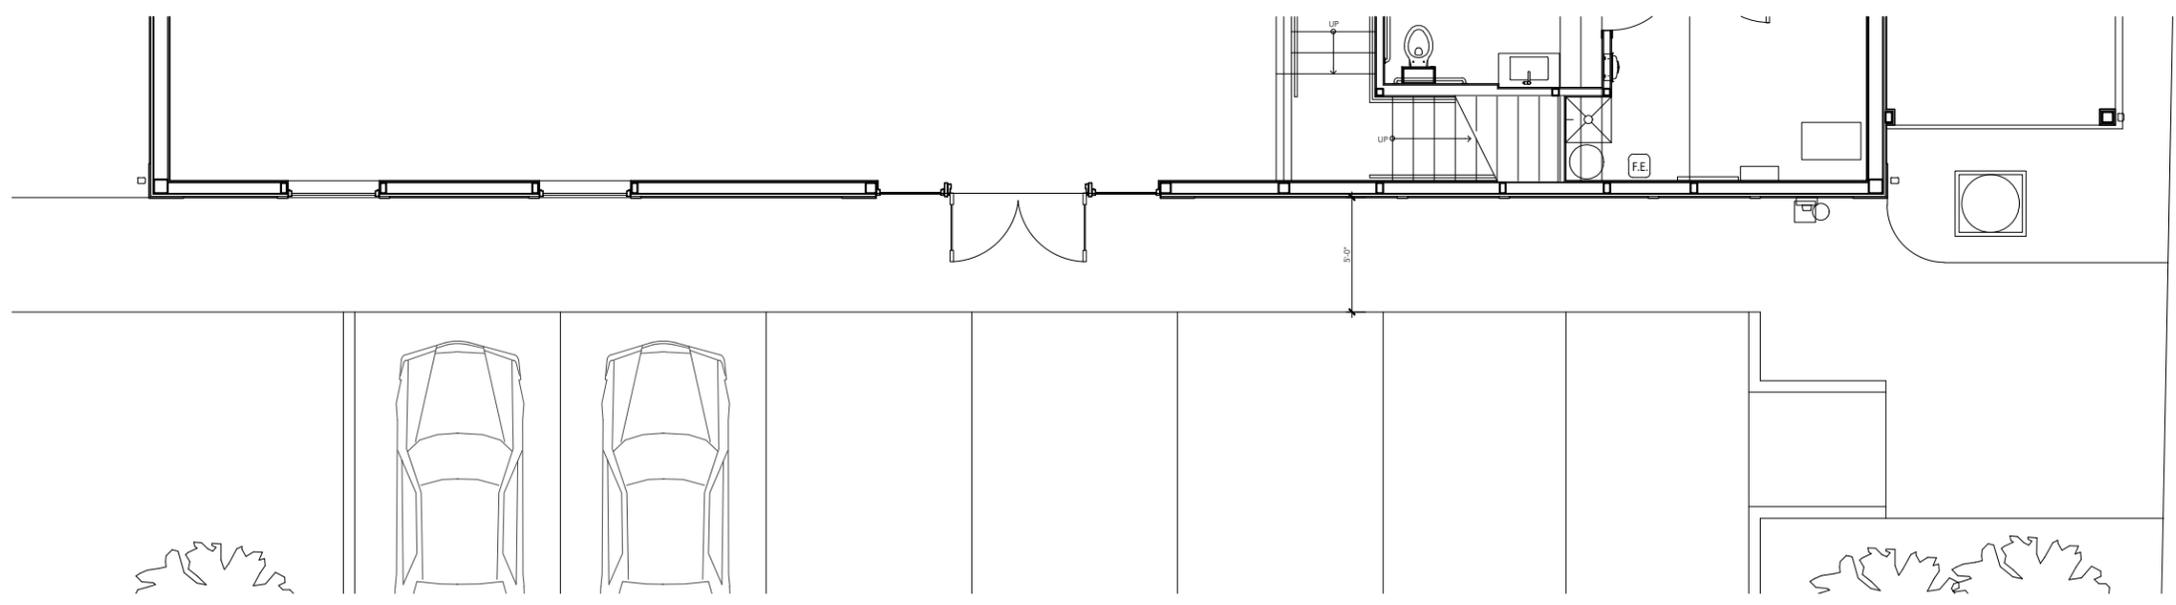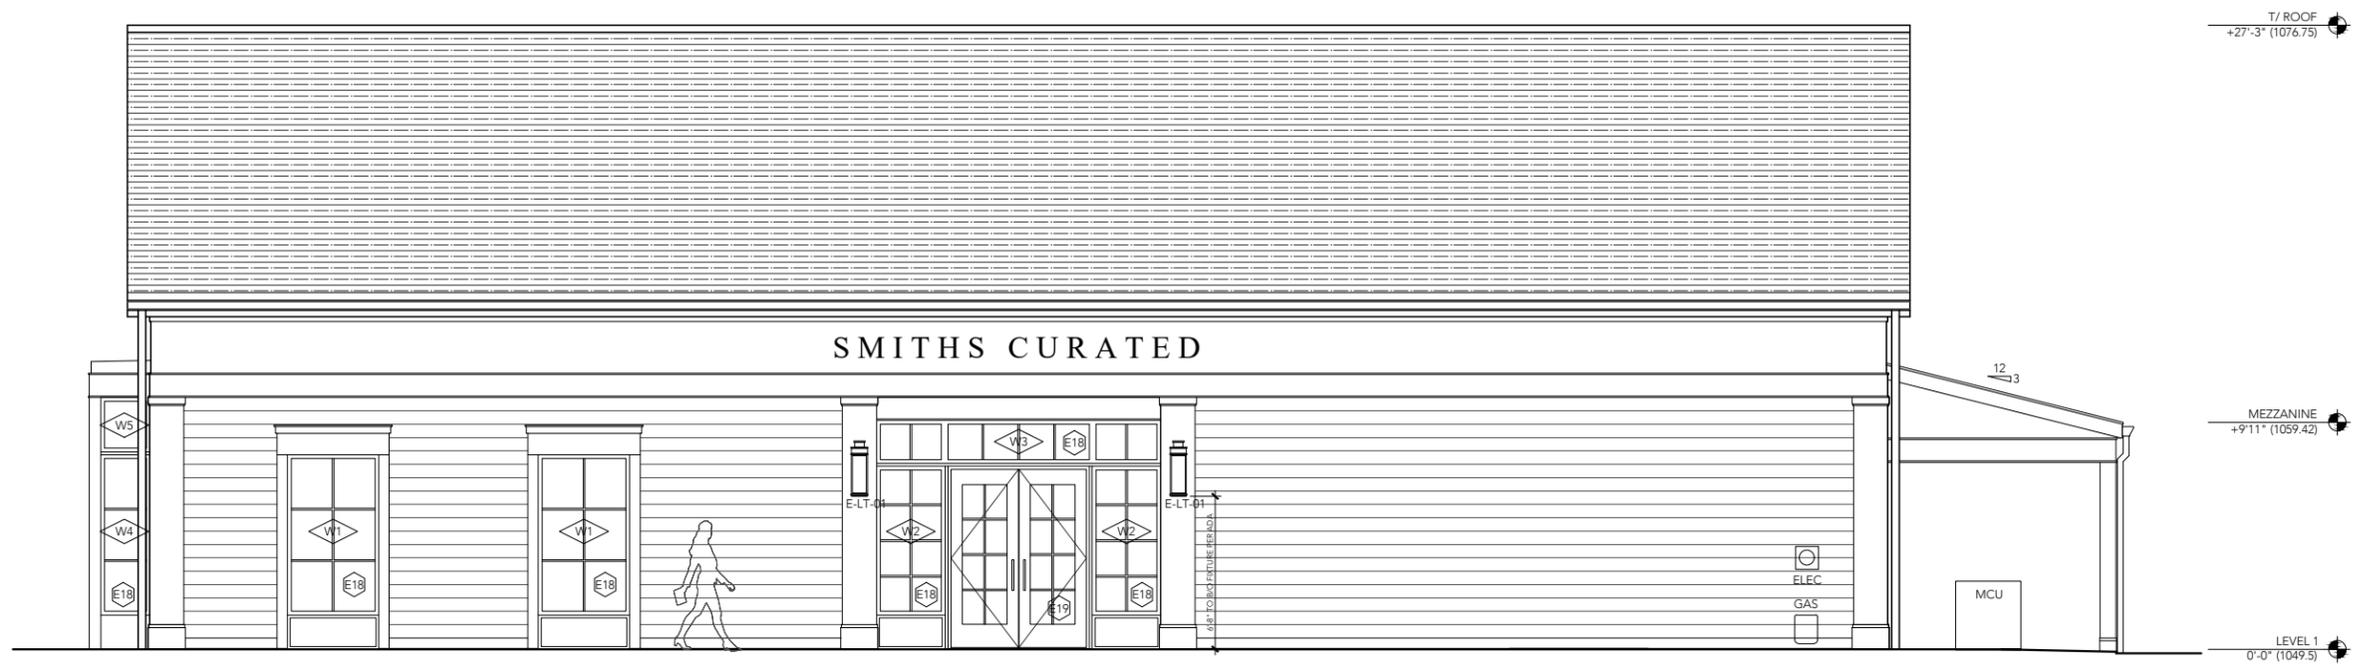

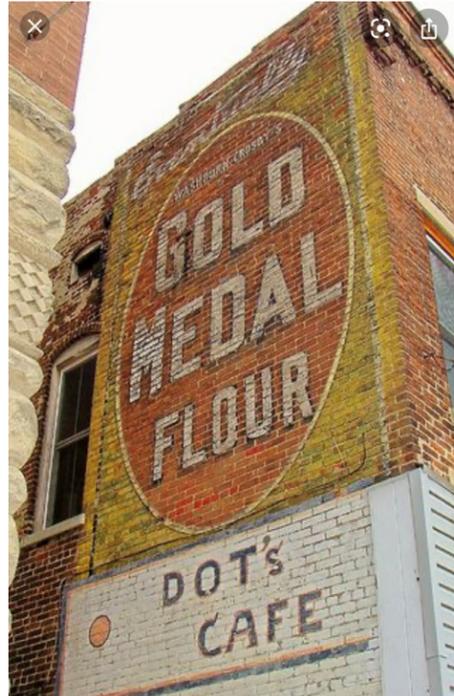

PRECEDENT IMAGES



PROJECT INFORMATION

PROPOSED NEW CONSTRUCTION  
**SMITHS CURATED BLDG.**  
48 CLINTON STREET  
HUDSON, OH 44236

GA PROJECT NO. 2020.013

PROFESSIONAL SEAL



GA PROJECT NO. 2020.013

DRAWING ISSUE RECORD

DATE TITLE

REVISION SCHEDULE

NO. DATE DESCRIPTION


SHEET DATE 05/14/2021  
ISSUED FOR PERMIT / BID

SHEET TITLE

FOUNDATION PLAN

SHEET NO.

**S3**

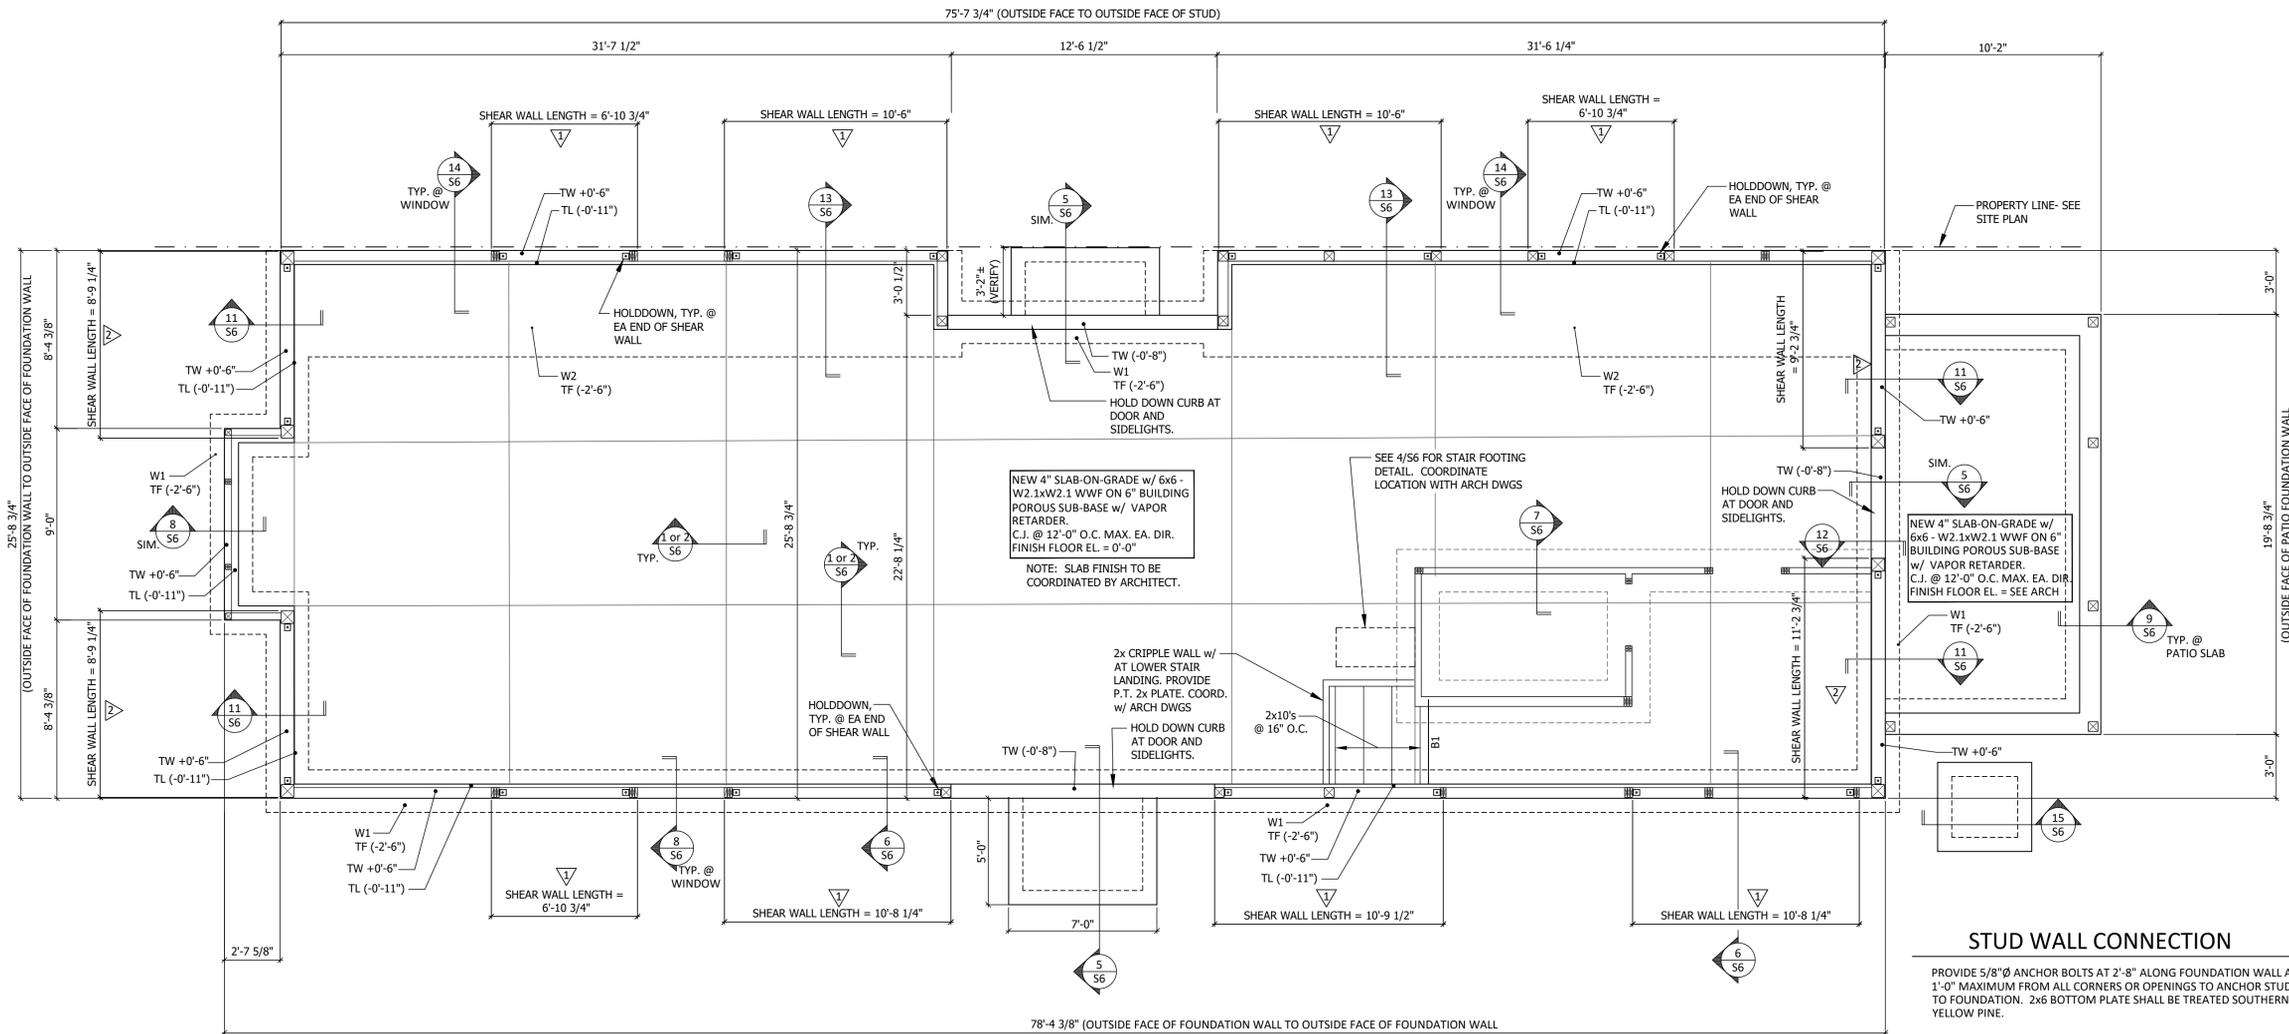

**STUD WALL CONNECTION**


PROVIDE 5/8"Ø ANCHOR BOLTS AT 2'-8" ALONG FOUNDATION WALL AND 1'-0" MAXIMUM FROM ALL CORNERS OR OPENINGS TO ANCHOR STUD WALL TO FOUNDATION. 2x6 BOTTOM PLATE SHALL BE TREATED SOUTHERN YELLOW PINE.

**FOUNDATION PLAN**

SCALE: 1/4" = 1'-0"

FOUNDATION NOTES:

- CONTRACTOR SHALL PROVIDE FROST AND MOISTURE PROTECTION FOR FOOTINGS EXPOSED DURING CONSTRUCTION
- REFER TO ARCHITECTURAL DRAWINGS OR PLUMBING DRAWINGS FOR SPECIFIC FLOOR DRAIN LOCATIONS & ELEVATIONS
- COORDINATE WALL DIMENSIONS WITH ARCHITECTURAL DRAWINGS
- FOOTING EXCAVATIONS SHALL BE EXAMINED BY THE GEOTECHNICAL ENGINEER TO CONFIRM THAT THE SOILS AT THE BOTTOM OF THE EXCAVATION ARE COMPETENT FOR 2000 psf BEARING PRESSURE.
- NO PROVISION HAS BEEN MADE FOR FUTURE EXPANSION
- SEE S6 FOR MISC. DETAILS NOT CUT ON PLAN
- ELEV. NOTED THUS (±X'-X") ON PLAN ARE REFERENCED FROM F.F. = 0'-0" SEE SITE PLAN FOR FINISH FLOOR ELEVATION.
- FOOTINGS ARE CENTERED UNDER COLUMN U.N.O. COLUMNS ARE CENTERED ON COLUMN LINES U.N.O.
- REFER TO ARCHITECTURAL DRAWING FOR LOCATIONS AND DIMENSIONS OF ALL FROST SLABS PRIOR TO CONSTRUCTION
- ALL DIMENSIONS ARE FOR GENERAL INFORMATION PURPOSES ONLY. COLUMN CENTERLINES AND COLUMN BEARING ELEVATIONS SHALL BE COORDINATED WITH THE ARCHITECTURAL DRAWINGS.
- BOTTOM OF FOOTING MUST BE MAINTAINED AT (-3'-6") BELOW EXTERIOR GRADE ALONG EXTERIOR WALLS
- WALL LEGEND: = CONCRETE WALL
- REFER TO S4 AND S5 FOR POST CALL OUTS AND POST SCHEDULE.
- IT IS THE CONTRACTORS RESPONSIBILITY TO COORDINATE BETWEEN THE ARCHITECTURAL AND STRUCTURAL DRAWINGS. IT IS NOT INTENDED THAT THE STRUCTURAL DRAWINGS BE USED INDEPENDENTLY OF THE ARCHITECTURAL DRAWINGS. ANY DISCREPANCIES, INCLUDING DIMENSIONS, SHALL BE BROUGHT TO THE ATTENTION OF THE ARCHITECT BEFORE PROCEEDING WITH THE WORK.

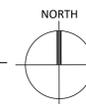

**BRACED WALL PANEL (SHEAR WALL) SCHEDULE**

SW	SHEATHING	EDGE	FIELD	SIMPSON HOLDOWN w/ ANCHOR	PLATE / ANCHOR BOLT	REMARKS
1	7/16" APA RATED WALL SHEATHING AT EXTERIOR FACE	8d @ 4" O.C.	8d @ 12" O.C.	SIMPSON HDU5-SDS2.5 w/ 2 - 2 x 6's EA. END (U.N.O. ON PLAN) w/ 5/8" Ø ANCHOR BOLT	5/8" DIA. F1554 @ 32" O.C. W/ WASHER	PLYWOOD ON EXTERIOR FACE OF STUDS. SEE 10/S6.
2	7/16" APA RATED WALL SHEATHING AT BOTH FACES	8d @ 4" O.C.	8d @ 12" O.C.	SIMPSON HD12 w/ 8x8 POST @ EA. END w/ 1 1/8" Ø ANCHOR BOLT	5/8" DIA. F1554 @ 32" O.C. W/ WASHER	PLYWOOD ON EXTERIOR AND INTERIOR FACE OF STUDS. SEE 10/S6.
***	1/2" APA RATED WALL SHEATHING.	8d @ 6" O.C.	8d @ 12" O.C.		5/8" DIA. ANCHOR BOLTS @ 32" O.C. W/ WASHER	

\*\*\* REQUIREMENTS FOR EXTERIOR NON-SHEARWALL WALLS

- BLOCK ALL UNSUPPORTED EDGES WITH 2x MATERIAL U.N.O. BLOCK EDGES WITH 3x MATERIAL WHERE 10d NAILING IS 3" O.C. OR LESS AND 8d NAILING IS 2" O.C. OR LESS. ALL PLYWOOD NAILS SHALL BE COMMON WIRE. SEE SPECIFICATIONS FOR OTHER NAIL REQUIREMENTS.
- EXTERIOR WALLS NOT DESIGNATED AS SHEAR WALLS IN THE WALL FRAMING PLAN SHALL MEET REQUIREMENTS INDICATED FOR NON-SHEAR WALL WALLS IN THE SCHEDULE ABOVE.
- SHEAR WALL LENGTHS WHERE NOTED ARE MINIMUM. DO NOT LOCATE HOLD-DOWNS FROM THESE DIMENSIONS. SEE ARCH DWGS FOR ACTUAL WALL LENGTHS.
- HD REFERS TO SIMPSON STRONGTIE CO. HOLD-DOWNS. INSTALL PER 2/S3.1. POST WIDTH SHALL MATCH STUD WALL WIDTH.
- EDGE NAIL WALL PLY TO STUDS OR POSTS WITH HOLD-DOWNS.
- WHERE PANELS ARE APPLIED TO BOTH FACES OF A WALL AND NAIL SPACING IS LESS THAN 6" O.C. ON EITHER SIDE, PANEL JOINTS SHALL BE OFFSET TO WALL ON DIFFERENT FRAMING MEMBERS OR FRAMING SHALL BE 3x OR THICKER AND NAILS ON EACH SIDE SHALL BE STAGGERED.
- NO POST INSTALLED ANCHORS WILL BE PERMITTED FOR HOLD-DOWN ANCHORS. COORDINATE LAYOUT PRIOR TO CONCRETE POUR.

MARK	DIMENSIONS			REINFORCEMENT	REMARKS
	WIDTH	LENGTH	DEPTH		
W1	2'-0"	-	1'-0"	(3) - #5 x CONT.	TYPICAL EXTERIOR WALL FOOTING TOP OF FOOTING = (-2'-6") TYP. U.N.O. BOTT. OF FOOTING = (3'-6") MINIMUM BELOW GRADE
W2	5'-0"	-	1'-0"	(6) - #5 x CONT. w/ #5 @ 12" O.C. TRANSVERSE	TYPICAL EXTERIOR WALL FOOTING TOP OF FOOTING = (-2'-6") TYP. U.N.O. BOTT. OF FOOTING = (3'-6") MINIMUM BELOW GRADE

**NOTE:**

GEOPIER RAMMED AGGREGATE PIER ELEMENTS WILL BE USED TO REINFORCE SOILS BENEATH THE BUILDING COLUMN, BEARING WALL FOUNDATIONS AND FLOOR SLAB. THE USE OF GEOPIER SOIL REINFORCEMENT SYSTEM WILL ALLOW FOR THE STRUCTURAL LOADS TO BE SUPPORTED ON CONTINUOUS WALL FOOTINGS AND COLUMN SPREAD FOOTINGS. FOUNDATIONS TO BE CONSTRUCTED ON SOIL IMPROVED BY THIS TECHNOLOGY HAS BEEN DESIGNED USING AN ALLOWABLE SOIL BEARING PRESSURE OF 2,000 PSF MIN.

**INSTALLATION OF SERVICES FOLLOWING STONE COLUMN INSTALLATION**


Where installation of services are proposed following installation of vibro stone columns, appropriate measures need to be taken by the contractor installing the foundations and services, to ensure that the integrity of the vibro stone column treatment is not compromised. As a general rule, any excavation which potentially intersects a line drawn down at 45 degrees at underside of foundation level (or floor slab subgrade for slab columns, if applicable) will potentially impact on the integrity of the treated ground due to disturbance of the treated ground. Where this occurs, the disturbed soil should be removed and replaced with suitable granular material placed and compacted in layers or lean mix concrete until back above the 45-degree line, (dependent upon the requirements of the Local Authority).

LEGEND


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	-INDICATES ELEVATION NUMBER -INDICATES DWG SHEET NUMBER		-INDICATES PLUMBING OR EQUIPMENT (SEE SHEET A6.05)
	-INDICATES SECTION NUMBER -INDICATES DWG SHEET NUMBER		-INDICATES ROOM NAME -INDICATES ROOM NUMBER
	-INDICATES KEY NOTE NUMBER (SEE KEY NOTE LEGEND, THIS SHEET)		-INDICATES MILLWORK ITEMS
	-INDICATES WINDOW TYPE		-INDICATES WALL ASSEMBLY TYPE NUMBER (SEE WALL TYPE SHEET)
	-INDICATES DOOR NUMBER (SEE DOOR SCHEDULE)		

KEY NOTES: PLAN

- |  |  |  |   |
|--|--|--|---|
| P1. ASPHALT SHINGLE (CERTAINTED LANDMARK PRO, MAX DEF MOIRE BLACK)<br>ON SYNTHETIC UNDERLAYMENT ON 3/8" APA RATED SHEATHING                                | P16. 7/16" APA RATED SHEATHING, EA. SIDE OF 2x8 STUDS @ 16" O.C.   | P33. FIBER CEMENT TRIM BOARD. 3/8" x 11.25" SMOOTH   | P51. X  |
| P2. RIDGE VENT   | P17. X   | P34. FIBER CEMENT TRIM BOARD. 3/8" x 5.5" SMOOTH   | P52. X  |
| P3. 24" SQ. MOP SINK. SEE PLUMBING   | P18. PELLA IMPERVA WINDOW, DIRECT SET, FIXED WINDOW, APPLIED GRILLES (ALUM. DS1, 3/4"), BOTH SIDES. BLACK FINISH BOTH SIDES              | P35. FIBER CEMENT TRIM BOARD. 3/8" x 7.25" SMOOTH  | P53. X  |
| P4. WATER BOTTLE FILLING STATION   | P19. PELLA RESERVE COMMERCIAL ENTRY DOOR, APPLIED GRILLES AND BLACK FINISH BOTH SIDES  | P36. FIBER CEMENT TRIM BOARD. 3/8" x 9.25" SMOOTH  | P54. X  |
| P5. FIRE EXTINGUISHER, SURFACE MOUNTED. MAINTAIN APPROCH CLEARANCE IN FRONT.   | P20. X   | P37. FIBER CEMENT TRIM BOARD. 3/8" x 11.25" SMOOTH   | P55. 6x6 TREATED WOOD POSTS. SIMPSON POST CAP AND BASE, TYP.  |
| P6. 1" CONTINUOUS RIGID INSULATION (R-5) OVER CONTINUOUS FULLY ADHERED VAPOR BARRIER. EXTEND RIGID INSULATION TO TOP PLATE. RODENT PROTECTION CAP AT BASE. | P21. X   | P38. FIBER CEMENT SMOOTH PANEL BOARD   | P56. 3/4" PLYWOOD SUB-FLOOR ON 2x12 WOOD JOISTS @ 16" O.C., DBL. EVERY OTHER. SEE STRUCTURAL  |
| P7. BUILT-IN WOOD WINDOW SEAT. UPHOLSTERED CUSHION PROVIDED BY OWNER   | P22. X   | P39. 2x2 EXTERIOR TRIM   | P57. X  |
| P8. 6" K STYLE GUTTER, MATCH TRIM COLOR  | P23. CONSTRUCTION JOINT  | P40. 1x2 EXTERIOR TRIM   | P58. X  |
| P9. DOWNSPOUT, 3" x 4"   | P24. CONCRETE SLAB ON GRADE (INTEGRAL COLOR) OVER 6 MIL VAPOR BARRIER (CONTINUE UNDER ENTIRE SLAB) OVER 6" GRANULAR FILL. SEE STRUCTURAL | P41. 1x1 EXTERIOR TRIM   | P59. 3/8" GLASS-MAT PANELS, TYPE X  |
| P10. FLOOR BOX. LOCATION SHOWN FOR REFERENCE. REFER TO ELECTRICAL DRAWINGS FOR FULL POWER SCOPE OF WORK.   | P25. X   | P42. DECORATIVE WOOD RIDGE BEAM. STAINED   | P60. ROOF MEMBRANE FULLY ADHERED TO COVERBOARD ON TWO LAYERS BUILT-UP INSULATION. STAGGER JOINTS HORIZONTALLY & VERTICALLY. SLOPE TO DRAIN AT 1/4":1" THICKNESS (R-30) MIN. |
| P11. 5.25" UNFACED HIGH DENSITY FIBERGLASS BATT INSULATION (R-21)  | P26. FROST SLAB. SEE STRUCTURAL  | P43. DECORATIVE WOOD COLLAR TIE/BREAM. STAINED   | P61. WALL MOUNTED RECESSED GALLERY TRACK, MATCH WALL COLOR  |
| P12. X   | P27. SLOPE SIDEWALK 1/4":1" AWAY FROM BUILDING. MAX. 2% CROSS SLOPE. SEE CIVIL   | P44. 1x6 WOOD CASING, W/ 1" EDGE MOULDING. PAINTED   | P62. CEILING FAN, OWNER PROVIDED  |
| P13. X   | P28. X   | P45. 1x8 WOOD BASE. SQ. EDGE. PAINTED  | P63. DECORATIVE LIGHT FIXTURE. OWNER PROVIDED   |
| P14. 5/8" GYPSUM WALL BOARD, LEVEL 5 FINISH, PAINTED   | P29. FIBER CEMENT VENTED SOFFIT BOARD. 1/2" x 12" SMOOTH   | P46. 1x6 TONGUE & GROOVE WOOD PANELING, BOTH SIDE OF WALL, PAINTED. STAINED WOOD CAP             | P64. EXTERIOR WALL SCONCE. SEE ELECTRICAL   |
| P15. 7/16" APA RATED SHEATHING, EA. SIDE OF 2x6 STUDS @ 16" O.C.   | P30. FIBER CEMENT TRIM BOARD. 3/8" x 3.5" SMOOTH   | P47. BUILT-IN MILLWORK. OWNER PROVIDED. COORDINATE POWER & LIGHT LOCATIONS                       | P65. EXTERIOR SIGN LIGHT. SEE ELECTRICAL  |
|  | P31. FIBER CEMENT TRIM BOARD. 3/8" x 5.5" SMOOTH   | P48. RECESSED WALL MOUNTED KNOXBOX MODEL 3270, DARK BRONZE                                       | P66. EXTERIOR GFCI RECEPTACLES. SEE ELECTRICAL  |
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|  |  | P50. SPIRAL SUPPLY DUCT. PAINT TO MATCH CEILING. SEE MECHANICAL                                  |   |

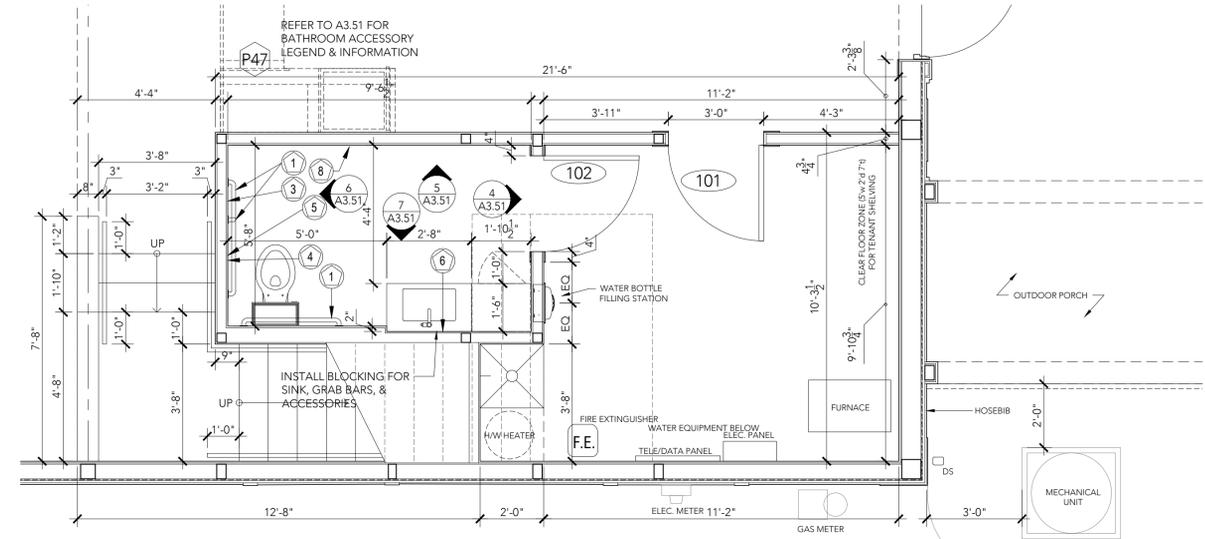

2 ENLARGED PLAN  
UTILITY & RESTROOM  
SCALE: 3/8" = 1'-0"  
PLAN NORTH

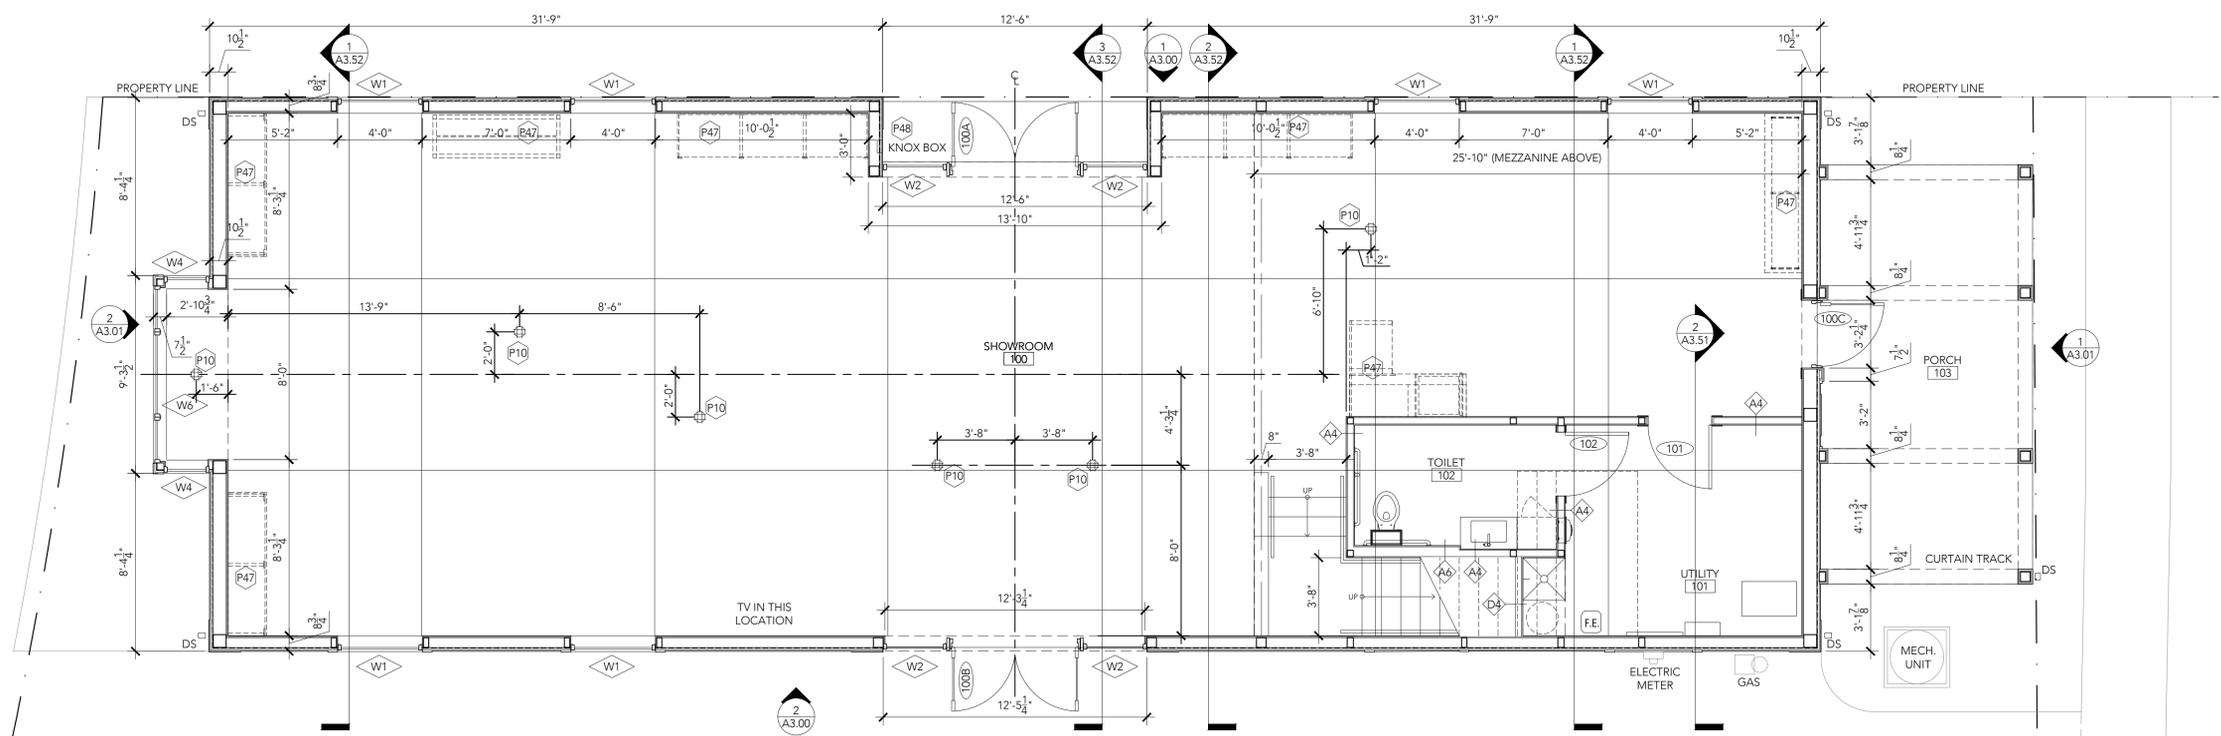

1 CONSTRUCTION PLAN  
FLOOR 1  
SCALE: 1/4" = 1'-0"  
PLAN NORTH

GIBBON ARCHITECTURE

3012 chadbourne road shaker, oh 44120  
216.385.5793

SMITHS CURATED

PROJECT INFORMATION

SMITHS CURATED BLDG.  
48 CLINTON STREET  
HUDSON, OH 44236

GA PROJECT NO. 2020.013

PROFESSIONAL SEAL



DATE: JEFFREY W GIBBON OH LICENSE: ARC.1416217  
EXPIRATION 12/31/2021

DRAWING ISSUE RECORD  
DATE: 2021-0514 TITLE: PERMIT / BID SET

REVISION SCHEDULE  
NO. DATE DESCRIPTION

SHEET DATE: 05/14/2021  
ISSUED FOR PERMIT / BID

SHEET TITLE: CONSTRUCTION PLAN FLOOR 1

SHEET NO. A2.00

LEGEND	
	-INDICATES DETAIL OR PLAN NUMBER -INDICATES DWG SHEET NUMBER
	-INDICATES ELEVATION NUMBER -INDICATES DWG SHEET NUMBER
	-INDICATES SECTION NUMBER -INDICATES DWG SHEET NUMBER
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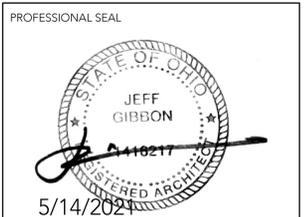
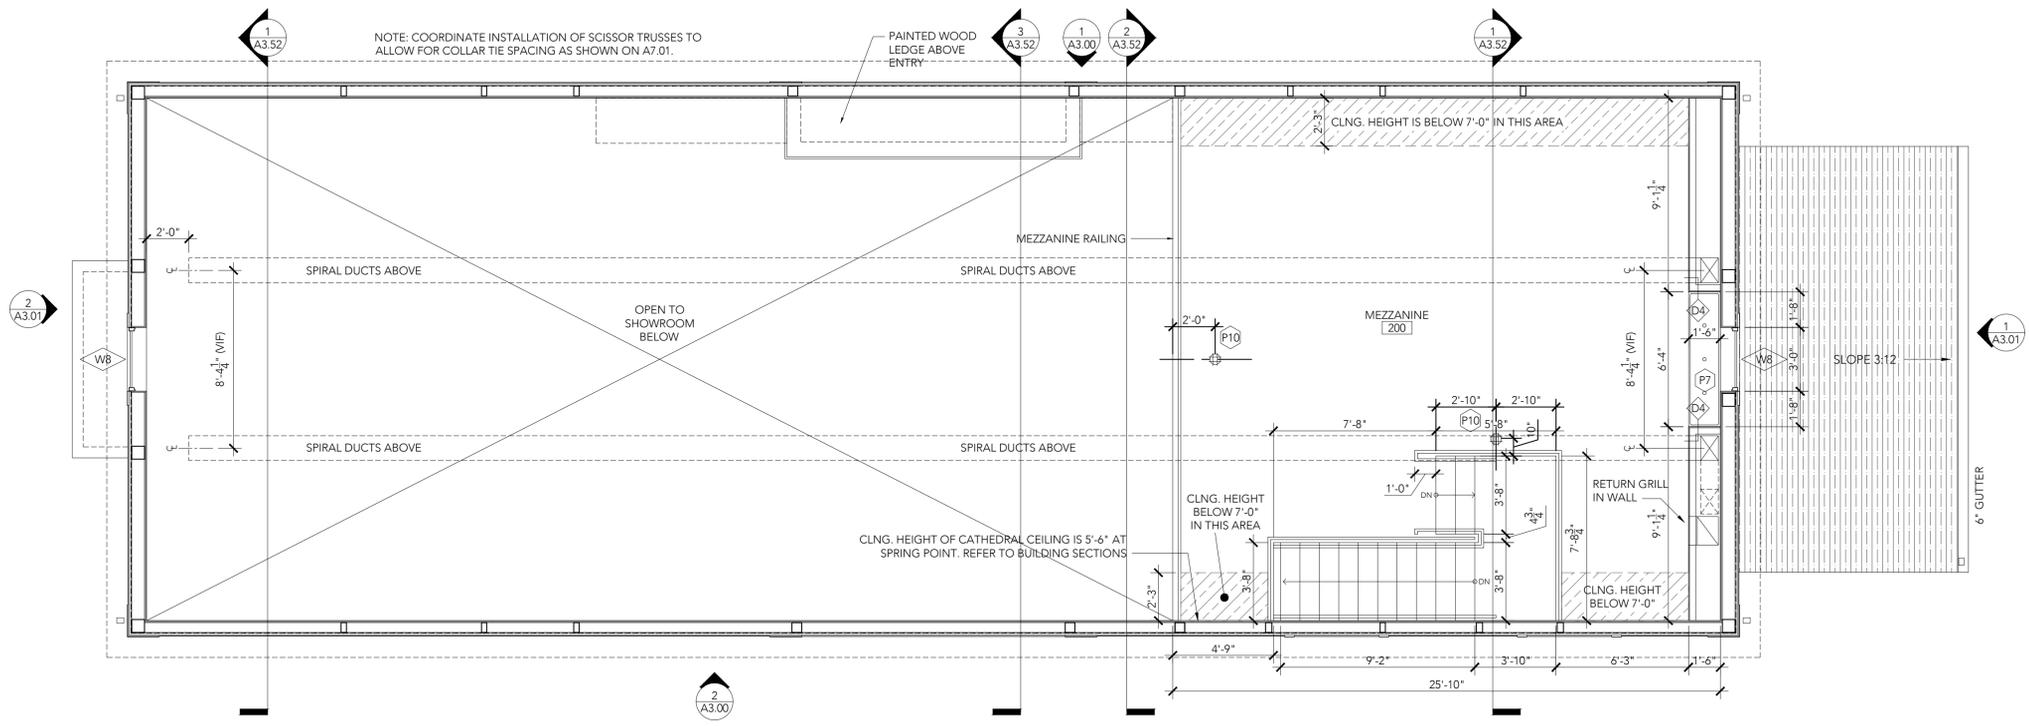


PROJECT INFORMATION

PROPOSED NEW CONSTRUCTION:  
**SMITHS CURATED BLDG.**  
48 CLINTON STREET  
HUDSON, OH 44236

ISSUED FOR PERMIT / BID

GA PROJECT NO. 2020.013



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REVISION SCHEDULE  
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SHEET DATE 05/14/2021  
ISSUED FOR PERMIT / BID

SHEET TITLE  
**CONSTRUCTION PLAN  
MEZZANINE**

SHEET NO.  
**A2.01**

LEGEND	
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	-INDICATES ELEVATION NUMBER -INDICATES DWG SHEET NUMBER
	-INDICATES SECTION NUMBER -INDICATES DWG SHEET NUMBER
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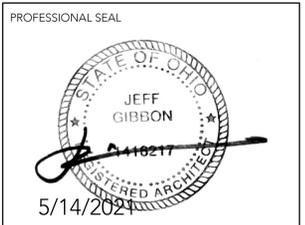
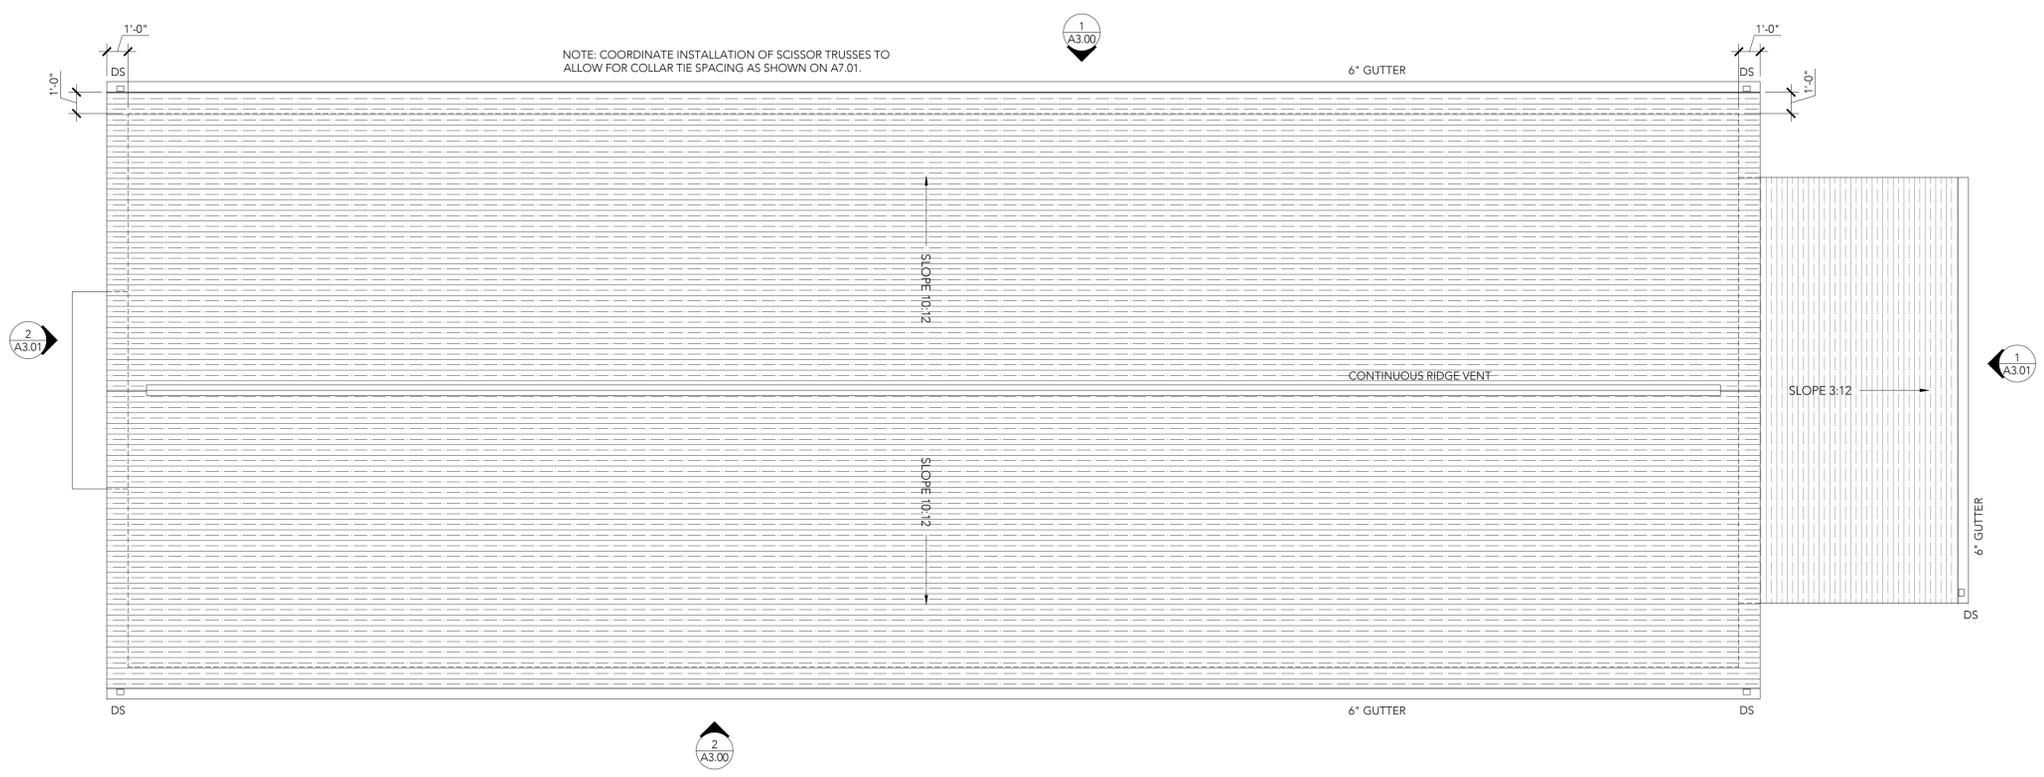
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48 CLINTON STREET  
HUDSON, OH 44236

ISSUED FOR PERMIT / BID

GA PROJECT NO. 2020.013



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DRAWING ISSUE RECORD

DATE	TITLE
2021-0514	PERMIT / BID SET

REVISION SCHEDULE

NO.	DATE	DESCRIPTION
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SHEET DATE 05/14/2021  
ISSUED FOR PERMIT / BID

SHEET TITLE  
**CONSTRUCTION PLAN  
ROOF**

SHEET NO.  
**A2.02**


WINDOW SCHEDULE

TAG	WINDOW	REMARKS				
	PANEL SIZE	SILL HEIGHT	MATERIAL	FINISH	GLAZING	
W1	4'-0" X 7'-0"	1'-6"	FG	BLK	DBL	TEMPERED
W2	3'-0" X 6'-6"	1'-6"	FG	BLK	DBL	TEMPERED
W3	12'-5 1/4" X 1'-10 1/2"	8'-1 1/2"	FG	BLK	DBL	TEMPERED
W4	2'-2" X 7'-0"	1'-6"	FG	BLK	DBL	TEMPERED
W5	2'-2" X 2'-4 1/2"	8'-7 1/2"	FG	BLK	DBL	
W6	8'-4" X 7'-0"	1'-6"	FG	BLK	DBL	TEMPERED
W7	8'-4" X 2'-4 1/2"	8'-7 1/2"	FG	BLK	DBL	
W8	3'-0" X 4'-8"	4'-0"	FG	BLK	DBL	TEMPERED
W9	3'-0" X 3'-0"	8'-9 1/2"	FG	BLK	DBL	


WINDOW & FRAME GENERAL NOTES:

- REFER TO EXTERIOR ELEVATIONS AND GENERAL NOTES FOR ADDITIONAL INFORMATION ON ALL WINDOWS.
- PELLA IMPERVIA FIBERGLASS WINDOWS WITH LOW-E COATING ON INSULATED GLAZING UNIT TYPICAL. DIRECT SET, FIXED WINDOWS. APPLIED GRILLES (ALUM. DS1 1/2") BOTH SIDES.
- PREFINISHED EXTERIOR AND INTERIOR WINDOW FRAME COLOR TO BE BLACK, INTERIOR & EXTERIOR
- SUBMIT SHOP DRAWINGS AND SAMPLES OF ALL WINDOWS AND RELATED ITEMS FOR REVIEW TO ARCHITECT INCLUDING ALL WINDOWS AND GLASS. SAMPLES TO INCLUDE GLASS / GLAZING UNITS, FLASHING, CAULKING COLORS, PAINT COLORS, SECURITY SCREENS.
- TEMPERED GLASS TO BE INSTALLED IF BOTTOM EDGE OF GLASS IS LESS THAN 18" ABOVE THE ADJACENT WALKING SURFACE OR FLOOR, OR AREA OF GLAZING IS GREATER THAN 9 SQUARE FEET.
- PER ASHRAE 90.1-2016, GLAZING: MAX. .31 U FACTOR & MAX. .38 SHGC

WINDOW TYPES:

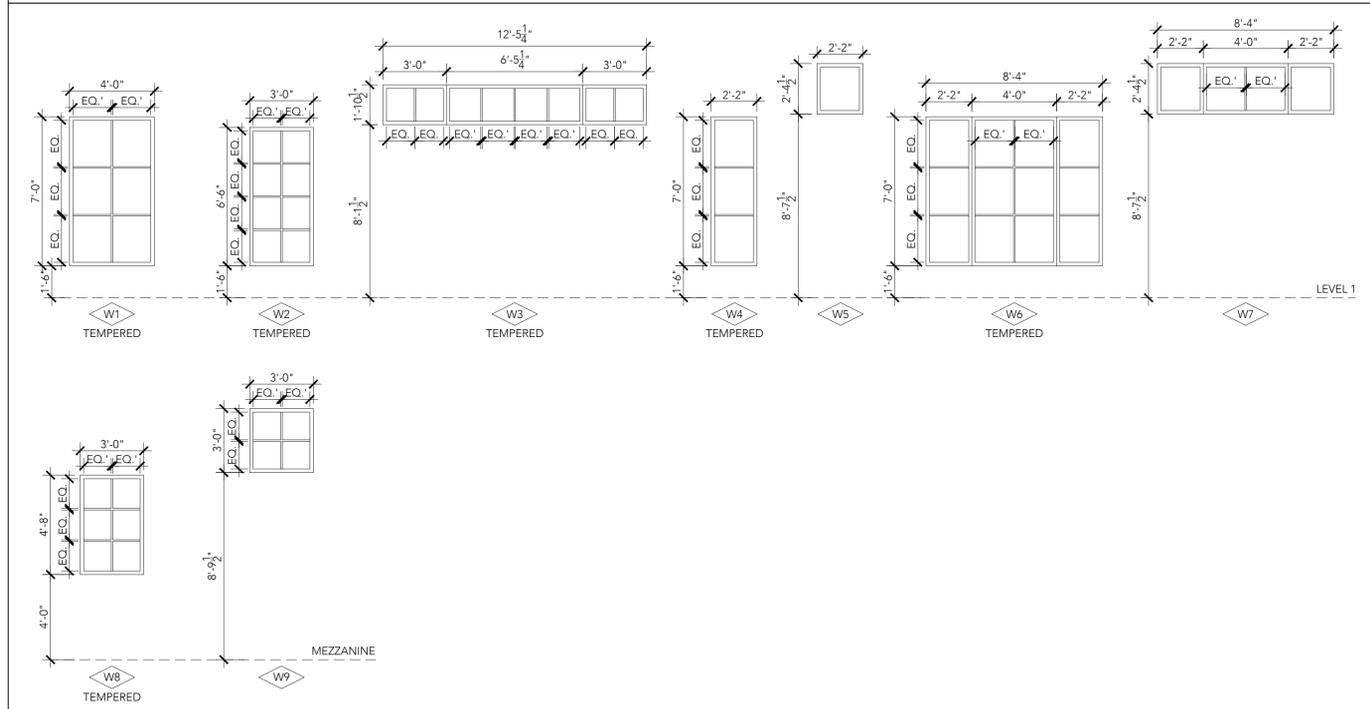

DOOR DETAILS

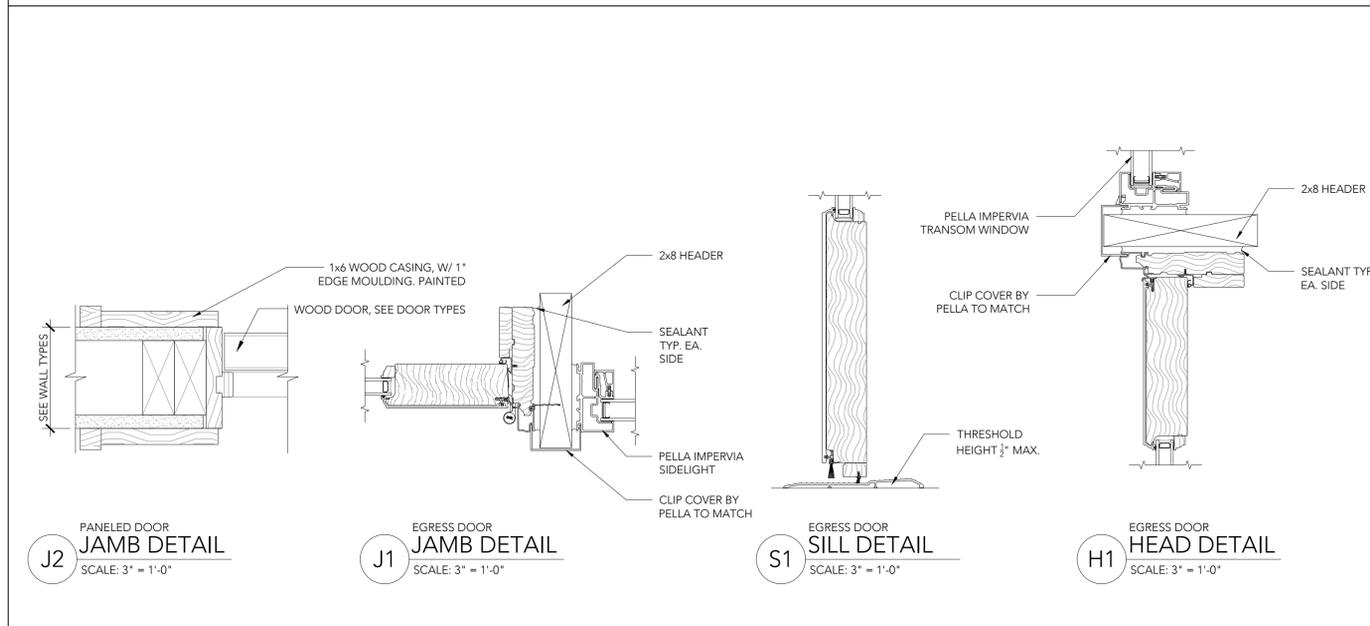


DOOR SCHEDULE

NO.	DESCRIPTION	DOOR	FRAME						DETAILS			REMARKS	
			MATERIAL	FINISH	HARDWARE	MATERIAL	FINISH	JAMB / SILL	HEAD	FIRE RATING (MIN)			
100A	SHOWROOM	D1	(2) 3'-0" X 8'-0"	2	ALWD	BLK	EGRESS	ALWD	PT	J1/S1	H1	-	ELEC. @ FRAME FOR SECURITY
100B	SHOWROOM	D1	(2) 3'-0" X 8'-0"	2	ALWD	BLK	EGRESS	ALWD	PT	J1/S1	H1	-	ELEC. @ FRAME FOR SECURITY
100C	SHOWROOM	D2	3'-0" X 8'-0"	2	ALWD	BLK	EGRESS	ALWD	PT	J1/S1	H1	-	ELEC. @ FRAME FOR SECURITY
101	UTILITY	D3	3'-0" X 7'-6"	1.75	WD	PT	CLASSROOM	WD	PT	J2			
102	TOILET	D3	3'-0" X 6'-8"	1.75	WD	PT	PRIVACY	WD	PT	J2			


DOOR & FRAME GENERAL NOTES:

- EXTERIOR DOORS TO BE PELLA RESERVE COMMERCIAL OUTSWING, ALUMINUM CLAD WOOD, TYPICAL APPLIED GRILLES (1/2") BOTH SIDES LOW-E, TEMPERED INSULATED GLAZING UNITS. FINISH BLACK, BOTH SIDES.
- ALL EXIT DOOR HARDWARE ALLOWS DOOR TO BE OPENED DIRECTLY IN THE DIRECTION OF EXIT WITHOUT THE USE OF A KEY OR SPECIAL KNOWLEDGE OR EFFORT (IBC 1017.4.1)
- PROVIDE THRESHOLDS WITH A MAXIMUM HEIGHT OF 1/2".
- ALLOWABLE CLOSURE PRESSURE SHALL BE 5 POUNDS FOR INTERIOR & EXTERIOR DOORS.
- IF REQ'D ALL ENTRANCE DOORS SHALL BE EQUIPPED WITH DEADBOLTS HAVING 1" THROW WITH EMBEDMENT OF AT LEAST 3/4".
- IF REQ'D BOTH THE LATCHING AND DEADBOLT DEVICES ON EXTERIOR DOORS SHALL RELEASE WITH A SINGLE ACTION OF THE INSIDE KNOB OR LEVER.
- HINGES FOR OUT-SWINGING EXTERIOR DOORS SHALL BE EQUIPPED WITH NON-REMOVABLE HINGE PINS.
- ALL DOOR ASSEMBLY TO HAVE "ADAAG - LEVER STYLE" HANDLES.
- HARDWARE FINISH & STYLE BY OWNER
- DOOR HANDLES SHALL BE CENTERED AT 40" ABOVE FINISHED FLOOR. BAR PULLS TO BE CENTERED ON DOOR SO THAT BAR IS STILL WITHIN THE RANGE OF 36" MIN - 44" MAX ABOVE FINISHED FLOOR.
- ALL HARDWARE, FRAME, AND DOOR SUBMITTALS AND RELATED SHOP DRAWINGS TO BE SENT TO ARCHITECT FOR APPROVAL PRIOR TO ORDERING OR INSTALL.
- GENERAL CONTRACTOR SHALL BE RESPONSIBLE FOR ALL FIELD DIMENSIONS PRIOR TO ORDERING AND INSTALL. IF ANY SIGNIFICANT DISCREPANCIES ARISE CONTACT ARCHITECT.
- TEMPERED, LOW-E GLASS TO BE PROVIDED FOR ANY DOOR.
- CONTRACTOR TO COORDINATE DOOR HARDWARE WITH OWNER, ARCHITECT, AND CLIENT'S SECURITY CONSULTANT
- PER ASHRAE 90.1-2016, GLAZING: MAX. .31 U FACTOR & MAX. .38 SHGC
- PROVIDE DOOR STOPS, TYPICAL
- INTERIOR DOORS, SOLID CORE, 1 PANEL, TYPICAL. PAINTED FINISH

DOOR TYPES:

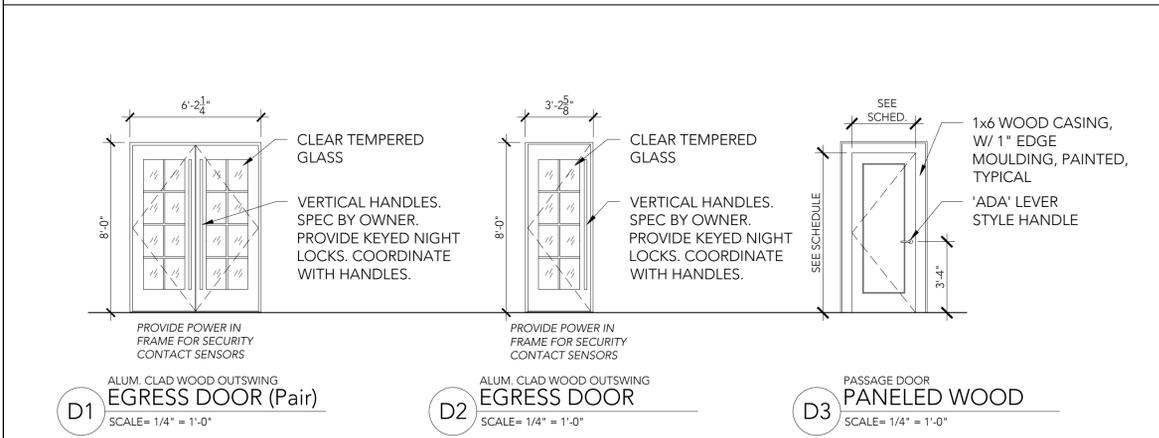

PARTITION TYPES

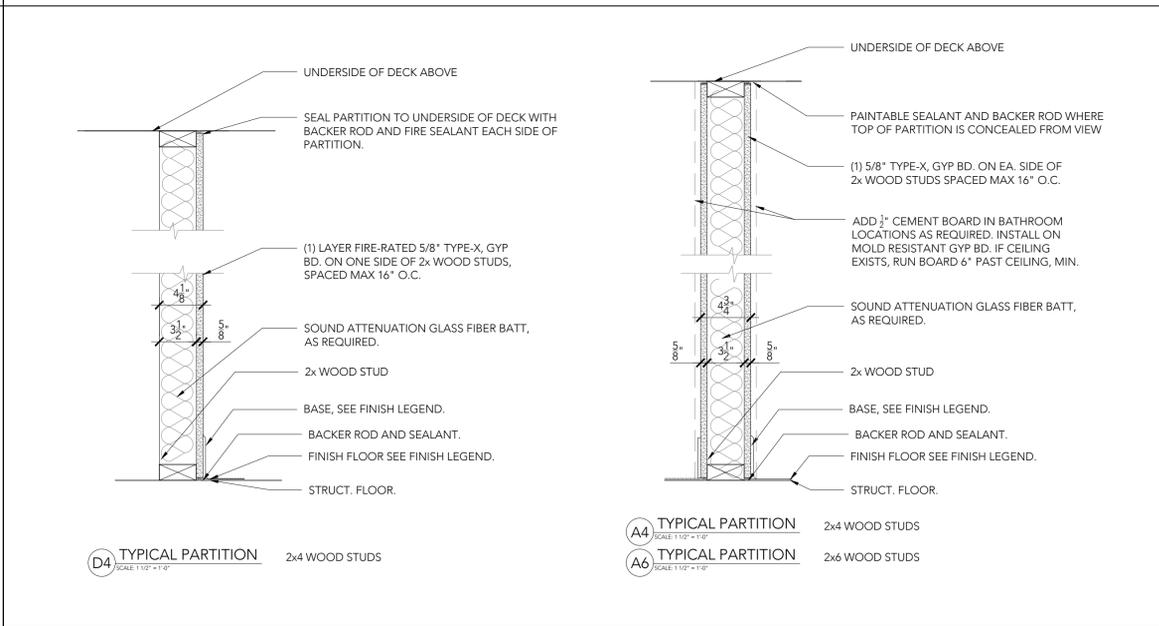

GIBBON ARCHITECTURE

3012 Chadbourne road shaker, oh 44120  
216.385.5793

SMITHS CURATED

PROJECT INFORMATION

SMITHS CURATED BLDG.  
48 CLINTON STREET  
HUDSON, OH 44236

GA PROJECT NO. 2020.013

PROFESSIONAL SEAL



DATE: JEFFREY W GIBBON OH LICENSE: ARC.1416217  
EXPIRATION 12/31/2021

DRAWING ISSUE RECORD

DATE	TITLE
2021-0514	PERMIT / BID SET

REVISION SCHEDULE

NO.	DATE	DESCRIPTION
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SHEET DATE: 05/14/2021  
ISSUED FOR PERMIT / BID

SHEET TITLE: DOOR, WINDOW, & PARTITION TYPES & SCHEDULES

SHEET NO.

A0.10

LEGEND

- INDICATES DETAIL OR PLAN NUMBER  
-INDICATES DWG SHEET NUMBER
- INDICATES ELEVATION NUMBER  
-INDICATES DWG SHEET NUMBER
- INDICATES SECTION NUMBER  
-INDICATES DWG SHEET NUMBER
- INDICATES KEY NOTE NUMBER  
(SEE KEY NOTE LEGEND, THIS SHEET)
- INDICATES ACCESSORY KEY NOTE  
(SEE LEGEND ON SHEET A3.51)
- INDICATES ELEVATION HEIGHT

KEY NOTES: ELEVATION/SECTION

GENERAL NOTES

1. REFER TO GENERAL NOTES AS WELL AS KEY NOTES ON ARCHITECTURAL PLANS. CONTRACTOR IS RESPONSIBLE TO COORDINATE BETWEEN INFORMATION ON ALL CONTRACT DOCUMENTS INCLUDING THE ARCHITECTURAL AND ENGINEERING DRAWINGS, AND INFORMATION PROVIDED BY THE OWNER AND INTERIOR DESIGNER.
2. REFER ALSO TO FIXTURE LEGEND ON A3.51 & FINISH LEGEND ON A3.52.
3. ITEMS NOTED AS "OWNER PROVIDED" WILL BE SPECIFIED AND PURCHASED BY OWNER AND/OR INTERIOR DESIGNER. GC TO INSTALL. GC TO COORDINATE DELIVERY, INSTALLATION, AND LOGISTICS WITH OWNER.

KEY NOTES: ELEVATION/SECTION

- E1. ASPHALT SHINGLE (CERTAINTED LANDMARK PRO, MAX DEF MOIRE BLACK) ON SYNTHETIC UNDERLAYMENT ON 1/2" APA RATED SHEATHING. NO SUBSTITUTIONS.
- E2. CONTINUOUS RIDGE VENT, TO MATCH ROOFING FINISH.
- E3. FABRICATED SCISSOR TRUSS. 10:12 TOP CHORD, 8:12 BOTTOM CHORD. SIZE & LAYOUT BY TRUSS MANUFACTURER. PROVIDE SHOP DRAWINGS PRIOR TO FABRICATION. REFER TO STRUCTURAL DRAWINGS FOR ADDITIONAL INFORMATION. COORDINATE INSTALLATION OF SCISSOR TRUSSES TO ALLOW FOR COLLAR TIE SPACING AS SHOWN ON A7.01.
- E4. ATTIC VENTILATION BAFFLE (1" MIN. DEPTH) ATTACHED TO ROOF SHEATHING ABOVE.
- E5. CLOSURE CAP. 1" RIGID INSULATION (R-5) BTWN. ROOF JOISTS & ROUGH CUT AROUND RAFTER VENT. SEAL PERIMETER WITH EXPANDING FOAM SEALANT.
- E6. 1" CONTINUOUS RIGID INSULATION (R-5) OVER CONTINUOUS FULLY


- E7. METAL DRIP EDGE.
- E8. 6" K STYLE GUTTER, GUTTER COLOR TO MATCH TRIM.
- E9. DOWNSPOUT, 3" x 4". REFER TO PLUMBING AND CIVIL DRAWINGS.
- E10. 10.25" HIGH DENSITY "CATHEDRAL" FIBERGLASS BATT INSULATION (R-38 MIN.)
- E11. 5.25" UNFACED HIGH DENSITY FIBERGLASS BATT INSULATION (R-21)
- E12. 2" FOIL FACED POLYISO INSULATION (R-13) FASTENED TO UNDERSIDE OF TRUSS CHORD. TAPE SEAMS
- E13. 1/2" FURRING STRIPS
- E14. 5/8" GYPSUM WALL BOARD, LEVEL 5 FINISH, PAINTED
- E15. 5/8" APA RATED SHEATHING, EA. SIDE OF 2x6 STUDS @ 16" O.C.
- E16. 5/8" APA RATED SHEATHING, EA. SIDE OF 2x8 STUDS @ 16" O.C.
- E17. SEE STRUCTURAL FOR BEAM/HEADER SCHEDULE. RIGID INSULATION BETWEEN HEADERS, WHERE APPLICABLE
- E18. PELLA IMPERVIA WINDOW. DIRECT SET, FIXED WINDOW. APPLIED GRILLES (ALUM. D51, 1/2"), BOTH SIDES. BLACK FINISH BOTH SIDES
- E19. PELLA RESERVE COMMERCIAL ENTRY DOOR. APPLIED GRILLES AND BLACK FINISH BOTH SIDES
- E20. CONTINUOUS 2x6 TREATED PLATE WITH 3/8" DIA. ANCHOR BOLTS @ 32" O.C. SEE STRUCTURAL FOR DETAIL
- E21. CONCRETE FOUNDATION, FOOTING & GEOPIERS. SEE STRUCTURAL FOR DETAIL
- E22. 3" RIGID INSULATION (R-15) CONTINUOUS AT INSIDE FACE OF FOUNDATION

- E23. 1" ISO BOARD AT SLAB EDGE. BACKER ROD AND SEAL
- E24. EXPOSED AND FINISHED CONCRETE SLAB ON GRADE OVER 6 MIL VAPOR BARRIER (CONTINUE UNDER ENTIRE SLAB) OVER 6" GRANULAR FILL. SEE STRUCTURAL FOR SPECIFICATIONS AND DETAILS. SEE FINISH LEGEND FOR FINISH INFORMATION.
- E25. 6" AIR SPACE
- E26. FROST SLAB. SEE STRUCTURAL
- E27. SLOPE SIDEWALK 1/4":1" AWAY FROM BUILDING. MAX. 2% CROSS SLOPE. SEE CIVIL
- E28. MAINTAIN MIN. 2" CLEARANCE FROM GRADE TO FIBER CEMENT BOARD, TYP. IN ALL LOCATIONS
- E29. FIBER CEMENT VENTED SOFFIT BOARD. 1/2" x 12" SMOOTH
- E30. FIBER CEMENT TRIM BOARD. 3/4" x 3.5" SMOOTH
- E31. FIBER CEMENT TRIM BOARD. 3/4" x 5.5" SMOOTH
- E32. FIBER CEMENT TRIM BOARD. 3/4" x 7.25" SMOOTH
- E33. FIBER CEMENT TRIM BOARD. 3/4" x 11.25" SMOOTH
- E34. FIBER CEMENT TRIM BOARD. 3/4" x 5.5" SMOOTH
- E35. FIBER CEMENT TRIM BOARD. 3/4" x 7.25" SMOOTH
- E36. FIBER CEMENT TRIM BOARD. 3/4" x 9.25" SMOOTH
- E37. FIBER CEMENT TRIM BOARD. 3/4" x 11.25" SMOOTH
- E38. FIBER CEMENT SMOOTH PANEL BOARD
- E39. FIBER CEMENT, V-GROOVE ASPYRE ARTISAN. 1/2" x 7" EXPOSURE
- E40. 2x2 EXTERIOR TRIM
- E41. 1x2 EXTERIOR TRIM
- E42. 1/2" x 2 EXTERIOR TRIM


- E43. 1x1 EXTERIOR TRIM
- E44. DECORATIVE WOOD RIDGE BEAM. PRE-FABRICATED AND PRE-FINISHED. REFER TO 8/A4.00.
- E45. DECORATIVE WOOD COLLAR TIE/BEAM. PRE-FABRICATED AND PRE-FINISHED. REFER TO 7/A4.00.
- E46. 1x6 WOOD CASING, W/1" EDGE MOLDING, TYP. PAINTED
- E47. WOOD BASE. SQ. EDGE. PAINTED. SEE FINISH LEGEND.
- E48. 1x6 TONGUE & GROOVE WOOD PANELING, BOTH SIDE OF WALL, PAINTED. WOOD CAP. SEE FINISH LEGEND.
- E49. BUILT-IN MILLWORK. OWNER PROVIDED. COORDINATE, BLOCKING, POWER & LIGHTING, CONTROLS LOCATIONS.
- E50. RECESSED WALL MOUNTED KNOXBOX MODEL 3270, DARK BRONZE
- E51. METAL GUARD & STAIR HAND RAILS. PROVIDE SLEEVE/PLATE CONNECTIONS AT SUPPORT POSTS. OWNER PROVIDED. PRE-FINISHED AT SHOP. SHOP DRAWINGS TO BE PROVIDED BY VENDOR TO ARCHITECT AND GC.
- E52. SPIRAL SUPPLY DUCT. PAINT TO MATCH CEILING. SEE MECHANICAL
- E53. 2x6 OUTLOOKERS @ 24" O.C. SEE STRUCTURAL
- E54. SIMPSON TIE. SEE STRUCTURAL
- E55. 2x10 WOOD RAFTERS @ 16" O.C. SEE STRUCTURAL
- E56. 2x8 WOOD JOISTS @ 16" O.C.
- E57. 6x6 TREATED WOOD POSTS. SIMPSON POST CAP AND BASE, TYP.
- E58. 3/4" PLYWOOD SUB-FLOOR ON 2x12 WOOD JOISTS @ 16" O.C., DBL. EVERY OTHER. SEE STRUCTURAL
- E59. RESILIENT CHANNELS @ 16" O.C. AT RIGHT ANGLE TO JOISTS. TYPE S/W SCREW ATTACHMENTS TO JOISTS
- E60. METAL FLASHING

- E61. 3/4" GLASS-MAT PANELS, TYPE X
- E62. ROOF MEMBRANE FULLY ADHERED TO COVERBOARD ON TWO LAYERS. BUILT-UP INSULATION. STAGGER JOINTS HORIZONTALLY & VERTICALLY. SLOPE TO DRAIN AT 1/4":1". 6" THICKNESS (R-30) MIN.
- E63. DISPLAY REVEAL A1025 BY "AS HANGING DISPLAY SYSTEM". FULLY RECESSED/CONCEALED FLANGE WALL MOUNT GALLERY ALUMINUM TRACK. MATCH COLOR TO BE WHITE. ANCHOR TO STUDS AND BLOCKING PER INSTALLATION SPECIFICATIONS. CONFIRM FINAL MOUNTING HEIGHTS IN FIELD WITH OWNER.
- E64. CEILING FAN, OWNER PROVIDED. SEE MECHANICAL.
- E65. DECORATIVE LIGHT FIXTURE. OWNER PROVIDED. SEE ELECTRICAL.
- E66. EXTERIOR WALL SCONCE. SEE ELECTRICAL
- E67. EXTERIOR SIGN LIGHT. SEE ELECTRICAL
- E68. EXTERIOR GFCI RECEPTACLES. SEE ELECTRICAL
- E69. CONSTRUCTION JOINT.
- E70. CONTINUOUS METAL CURTAIN TRACK. OWNER PROVIDED. COORDINATE INSTALLATION WITH OWNER. CURTAINS PROVIDED BY OWNER.
- E71. EXTERIOR METAL BUILDING SIGN, INTERNALLY HALO LIT. INDIVIDUALLY MOUNTED PAINTED ALUMINUM LETTERS. EXTERIOR SIGNAGE WILL BE SUBMITTED SEPARATELY TO THE CITY OF HUDSON FOR APPROVAL. INSTALLATION TO OCCUR AS PART OF CONSTRUCTION.

- T/ ROOF  
+27'-3" (1076.75)
- BEARING PLATE  
15'-8" (1065.17)
- MEZZANINE  
+9'-11" (1059.42)
- LEVEL 1  
0'-0" (1049.5)
- BEARING PLATE  
15'-8" (1065.17)
- MEZZANINE  
+9'-11" (1059.42)
- STAIR LANDING  
+8'-2" (1057.67)
- LEVEL 1  
0'-0" (1049.5)

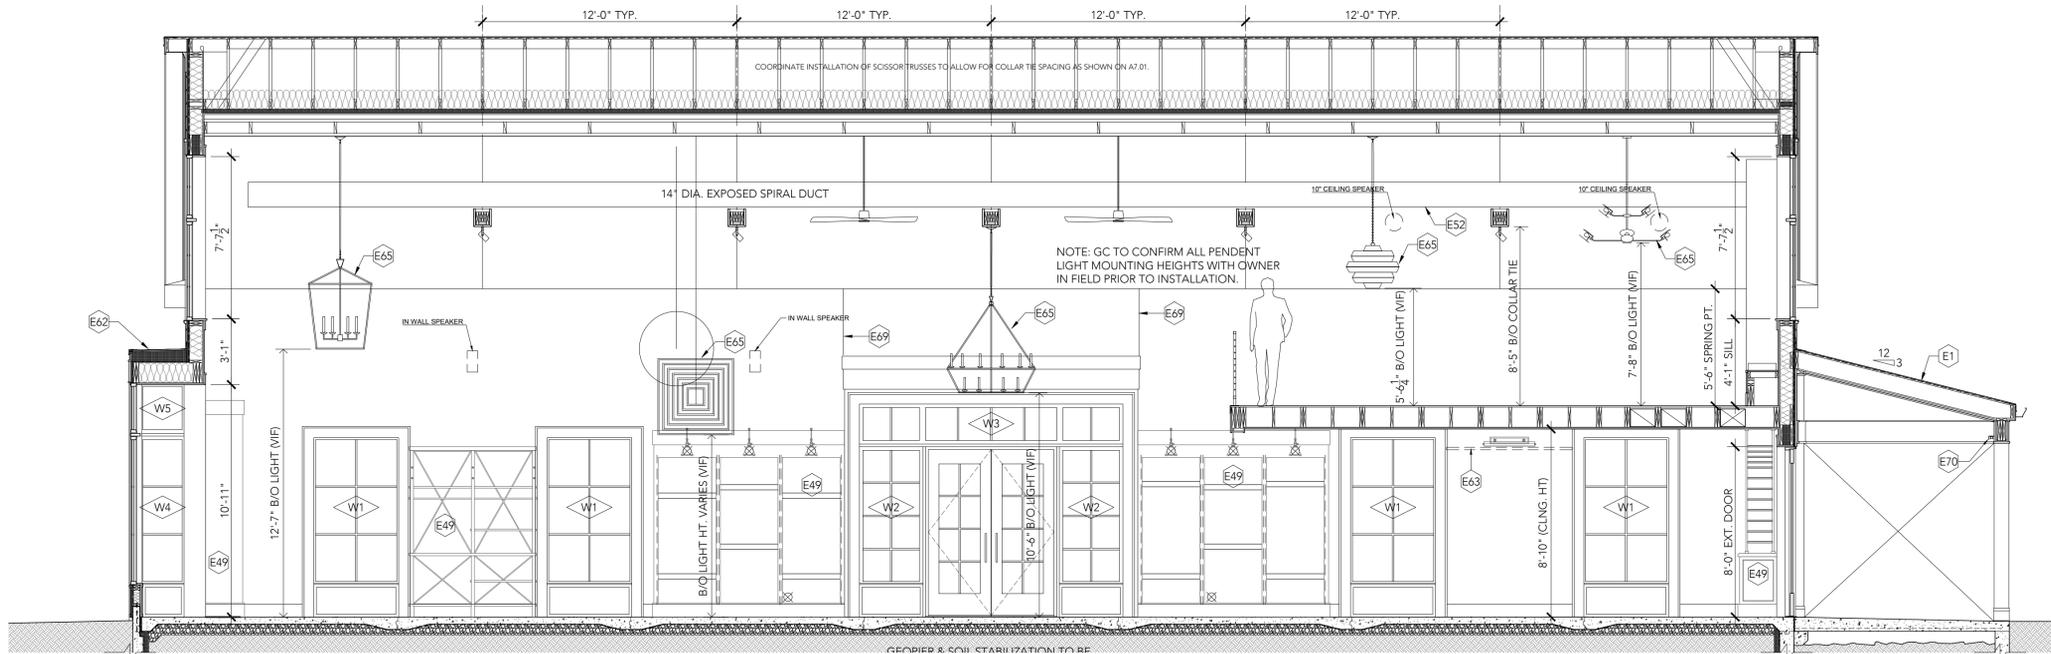

2 BUILDING SECTION  
SECTION FACING NORTH  
SCALE: 1/4" = 1'-0"

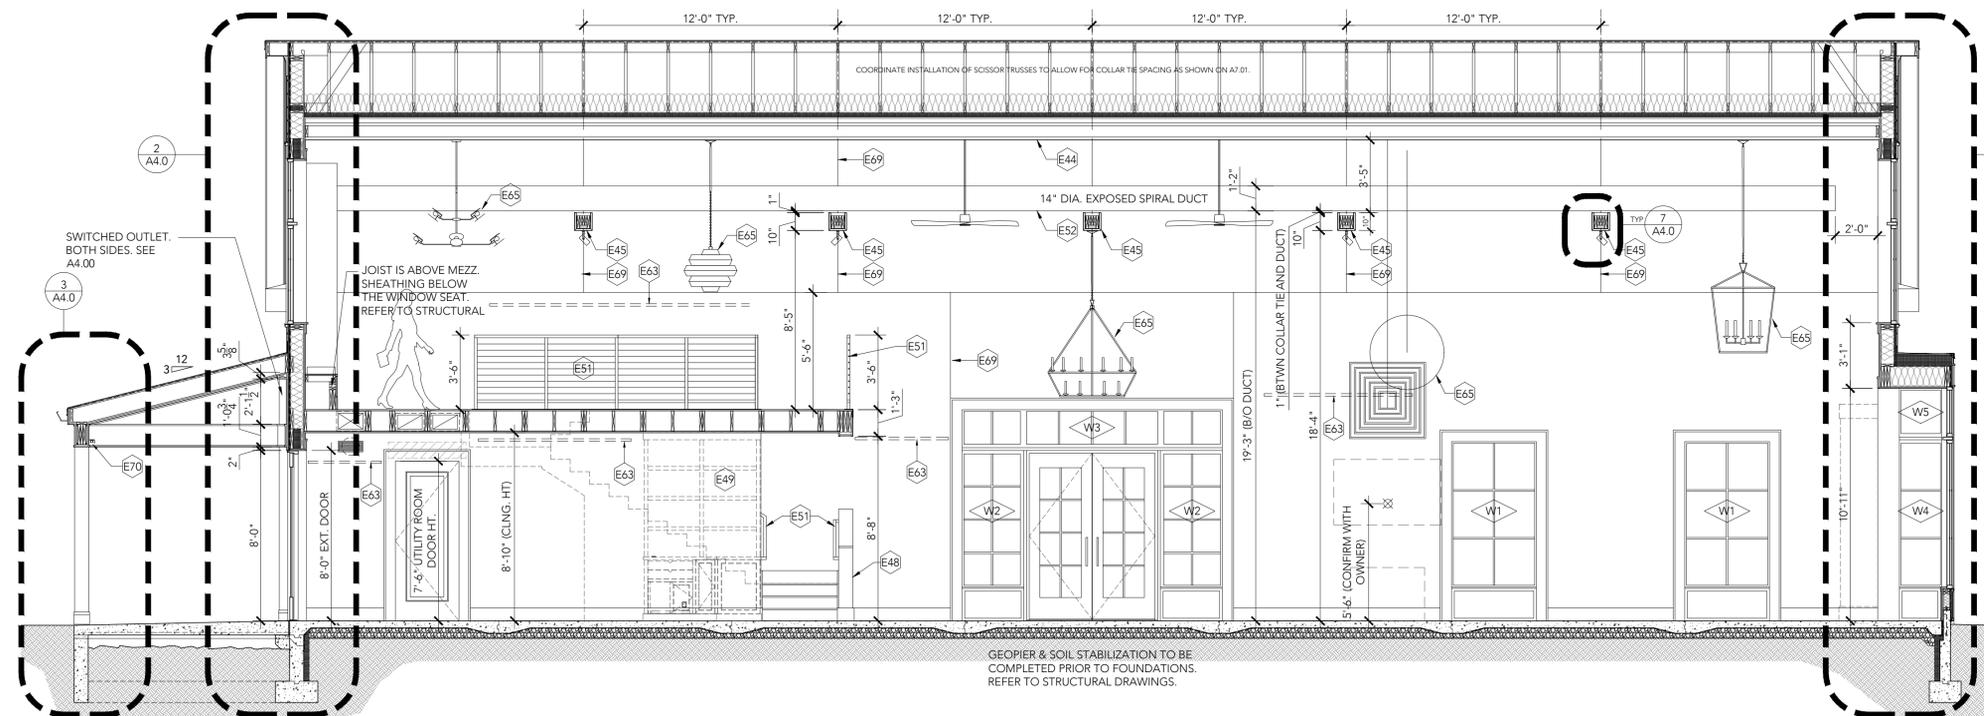

1 BUILDING SECTION  
SECTION FACING SOUTH  
SCALE: 1/4" = 1'-0"

**GIBBON**  
ARCHITECTURE  
3012 chadbourne road shaker, oh 44120  
216.385.5793

**SMITHS**  
CURATED

PROJECT INFORMATION

PROPOSED NEW CONSTRUCTION:  
**SMITHS CURATED BLDG.**  
48 CLINTON STREET  
HUDSON, OH 44236

GA PROJECT NO. 2020.013

ISSUED FOR PERMIT / BID

PROFESSIONAL SEAL

STATE OF OHIO  
JEFF GIBBON  
REGISTERED ARCHITECT  
A110217  
5/14/2021

DATE: JEFFREY W GIBBON OH LICENSE: ARC.1416217 EXPIRATION 12/31/2021

DRAWING ISSUE RECORD		
DATE	TITLE	
2021-0514	PERMIT / BID SET	
REVISION SCHEDULE		
NO.	DATE	DESCRIPTION

SHEET DATE: 05/14/2021  
ISSUED FOR PERMIT / BID

SHEET TITLE:  
**CONSTRUCTION  
BUILDING SECTIONS**

SHEET NO.  
**A3.50**

LEGEND

- INDICATES DETAIL OR PLAN NUMBER  
-INDICATES DWG SHEET NUMBER
- INDICATES ELEVATION NUMBER  
-INDICATES DWG SHEET NUMBER
- INDICATES SECTION NUMBER  
-INDICATES DWG SHEET NUMBER
- INDICATES KEY NOTE NUMBER  
(SEE KEY NOTE LEGEND, THIS SHEET)
- INDICATES ACCESSORY KEY NOTE  
(SEE LEGEND ON SHEET A3.51)
- INDICATES ELEVATION HEIGHT

KEY NOTES: ELEVATION/SECTION

GENERAL NOTES

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  2. REFER ALSO TO FIXTURE LEGEND ON A3.51 & FINISH LEGEND ON A3.52.
  3. ITEMS NOTED AS "OWNER PROVIDED" WILL BE SPECIFIED AND PURCHASED BY OWNER AND/OR INTERIOR DESIGNER. GC TO INSTALL. GC TO COORDINATE DELIVERY, INSTALLATION, AND LOGISTICS WITH OWNER.
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- E1. ASPHALT SHINGLE (CERTAINTED LANDMARK PRO, MAX DEF MOIRE BLACK) ON SYNTHETIC UNDERLAYMENT ON 1/2" APA RATED SHEATHING. NO SUBSTITUTIONS.
  - E2. CONTINUOUS RIDGE VENT, TO MATCH ROOFING FINISH.
  - E3. FABRICATED SCISSOR TRUSS. 10:12 TOP CHORD, 8:12 BOTTOM CHORD. SIZE & LAYOUT BY TRUSS MANUFACTURER. PROVIDE SHOP DRAWINGS PRIOR TO FABRICATION. REFER TO STRUCTURAL DRAWINGS FOR ADDITIONAL INFORMATION. COORDINATE INSTALLATION OF SCISSOR TRUSSES TO ALLOW FOR COLLAR TIE SPACING AS SHOWN ON A7.01.
  - E4. ATTIC VENTILATION BAFFLE (1" MIN. DEPTH) ATTACHED TO ROOF SHEATHING ABOVE.
  - E5. CLOSURE CAP. 1" RIGID INSULATION (R-5) BTWN. ROOF JOISTS & ROUGH CUT AROUND RAFTER VENT. SEAL PERIMETER WITH EXPANDING FOAM SEALANT.
  - E6. 1" CONTINUOUS RIGID INSULATION (R-5) OVER CONTINUOUS FULLY

- ADHERED VAPOR BARRIER. EXTEND RIGID INSULATION TO TOP PLATE. RODENT PROTECTION CAP AT BASE.
- E7. METAL DRIP EDGE.
  - E8. 6" K STYLE GUTTER, GUTTER COLOR TO MATCH TRIM.
  - E9. DOWNSPOUT, 3" x 4". REFER TO PLUMBING AND CIVIL DRAWINGS.
  - E10. 10.25" HIGH DENSITY "CATHEDRAL" FIBERGLASS BATT INSULATION (R-38 MIN.)
  - E11. 5.25" UNFACED HIGH DENSITY FIBERGLASS BATT INSULATION (R-21)
  - E12. 2" FOIL FACED POLYISO INSULATION (R-13) FASTENED TO UNDERSIDE OF TRUSS CHORD. TAPE SEAMS
  - E13. 1/2" FURRING STRIPS
  - E14. 5/8" GYPSUM WALL BOARD, LEVEL 5 FINISH, PAINTED
  - E15. 5/8" APA RATED SHEATHING, EA. SIDE OF 2x6 STUDS @ 16" O.C.
  - E16. 5/8" APA RATED SHEATHING, EA. SIDE OF 2x8 STUDS @ 16" O.C.
  - E17. SEE STRUCTURAL FOR BEAM/HEADER SCHEDULE. RIGID INSULATION BETWEEN HEADERS, WHERE APPLICABLE
  - E18. PELLA IMPERVIA WINDOW. DIRECT SET, FIXED WINDOW. APPLIED GRILLES (ALUM. D51, 1/2"), BOTH SIDES. BLACK FINISH BOTH SIDES
  - E19. PELLA RESERVE COMMERCIAL ENTRY DOOR. APPLIED GRILLES AND BLACK FINISH BOTH SIDES
  - E20. CONTINUOUS 2x6 TREATED PLATE WITH 3/8" DIA. ANCHOR BOLTS @ 32" O.C. SEE STRUCTURAL FOR DETAIL
  - E21. CONCRETE FOUNDATION, FOOTING & GEOPIERS. SEE STRUCTURAL FOR DETAIL
  - E22. 3" RIGID INSULATION (R-15) CONTINUOUS AT INSIDE FACE OF FOUNDATION







- E23. 1" ISO BOARD AT SLAB EDGE. BACKER ROD AND SEAL
- E24. EXPOSED AND FINISHED CONCRETE SLAB ON GRADE OVER 6 MIL VAPOR BARRIER (CONTINUE UNDER ENTIRE SLAB) OVER 6" GRANULAR FILL. SEE STRUCTURAL FOR SPECIFICATIONS AND DETAILS. SEE FINISH LEGEND FOR FINISH INFORMATION.
- E25. 6" AIR SPACE
- E26. FROST SLAB. SEE STRUCTURAL
- E27. SLOPE SIDEWALK 1/4" : 1" AWAY FROM BUILDING. MAX. 2% CROSS SLOPE. SEE CIVIL
- E28. MAINTAIN MIN. 2" CLEARANCE FROM GRADE TO FIBER CEMENT BOARD, TYP. IN ALL LOCATIONS
- E29. FIBER CEMENT VENTED SOFFIT BOARD. 1/4" x 12" SMOOTH
- E30. FIBER CEMENT TRIM BOARD. 3/4" x 3.5" SMOOTH
- E31. FIBER CEMENT TRIM BOARD. 3/4" x 5.5" SMOOTH
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- E33. FIBER CEMENT TRIM BOARD. 3/4" x 11.25" SMOOTH
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- E37. FIBER CEMENT TRIM BOARD. 3/4" x 11.25" SMOOTH
- E38. FIBER CEMENT SMOOTH PANEL BOARD
- E39. FIBER CEMENT, V-GROOVE ASPYRE ARTISAN. 1/2" x 7" EXPOSURE
- E40. 2x2 EXTERIOR TRIM
- E41. 1x2 EXTERIOR TRIM
- E42. 1/2" x 2 EXTERIOR TRIM

- E43. 1x1 EXTERIOR TRIM
- E44. DECORATIVE WOOD RIDGE BEAM. PRE-FABRICATED AND PRE-FINISHED. REFER TO 8/A4.00.
- E45. DECORATIVE WOOD COLLAR TIE/BEAM. PRE-FABRICATED AND PRE-FINISHED. REFER TO 7/A4.00.
- E46. 1x6 WOOD CASING, W/ 1" EDGE MOLDING, TYP. PAINTED
- E47. WOOD BASE. SQ. EDGE. PAINTED. SEE FINISH LEGEND.
- E48. 1x6 TONGUE & GROOVE WOOD PANELING, BOTH SIDE OF WALL, PAINTED. WOOD CAP. SEE FINISH LEGEND.
- E49. BUILT-IN MILLWORK. OWNER PROVIDED. COORDINATE, BLOCKING, POWER & LIGHTING, CONTROLS LOCATIONS.
- E50. RECESSED WALL MOUNTED KNOXBOX MODEL 3270, DARK BRONZE
- E51. METAL GUARD & STAIR HAND RAILS. PROVIDE SLEEVE/PLATE CONNECTIONS AT SUPPORT POSTS. OWNER PROVIDED. PRE-FINISHED AT SHOP. SHOP DRAWINGS TO BE PROVIDED BY VENDOR TO ARCHITECT AND GC.
- E52. SPIRAL SUPPLY DUCT. PAINT TO MATCH CEILING. SEE MECHANICAL
- E53. 2x6 OUTLOOKERS @ 24" O.C. SEE STRUCTURAL
- E54. SIMPSON TIE. SEE STRUCTURAL
- E55. 2x10 WOOD RAFTERS @ 16" O.C. SEE STRUCTURAL
- E56. 2x8 WOOD JOISTS @ 16" O.C.
- E57. 6x6 TREATED WOOD POSTS. SIMPSON POST CAP AND BASE, TYP.
- E58. 3/4" PLYWOOD SUB-FLOOR ON 2x12 WOOD JOISTS @ 16" O.C., DBL. EVERY OTHER. SEE STRUCTURAL
- E59. RESILIENT CHANNELS @ 16" O.C. AT RIGHT ANGLE TO JOISTS. TYPE S/W SCREW ATTACHMENTS TO JOISTS
- E60. METAL FLASHING

- E61. 3/4" GLASS-MAT PANELS, TYPE X
- E62. ROOF MEMBRANE FULLY ADHERED TO COVERBOARD ON TWO LAYERS. BUILT-UP INSULATION. STAGGER JOINTS HORIZONTALLY & VERTICALLY. SLOPE TO DRAIN AT 1/4" : 1". 6" THICKNESS (R-30) MIN.
- E63. DISPLAY REVEAL A1025 BY "AS HANGING DISPLAY SYSTEM". FULLY RECESSED/CONCEALED FLANGE WALL MOUNT GALLERY ALUMINUM TRACK. MATCH COLOR TO BE WHITE. ANCHOR TO STUDS AND BLOCKING PER INSTALLATION SPECIFICATIONS. CONFIRM FINAL MOUNTING HEIGHTS IN FIELD WITH OWNER
- E64. CEILING FAN, OWNER PROVIDED. SEE MECHANICAL.
- E65. DECORATIVE LIGHT FIXTURE. OWNER PROVIDED. SEE ELECTRICAL.
- E66. EXTERIOR WALL SCONCE. SEE ELECTRICAL
- E67. EXTERIOR SIGN LIGHT. SEE ELECTRICAL
- E68. EXTERIOR GFCI RECEPTACLES. SEE ELECTRICAL
- E69. CONSTRUCTION JOINT.
- E70. CONTINUOUS METAL CURTAIN TRACK. OWNER PROVIDED. COORDINATE INSTALLATION WITH OWNER. CURTAINS PROVIDED BY OWNER.
- E71. EXTERIOR METAL BUILDING SIGN, INTERNALLY HALO LIT. INDIVIDUALLY MOUNTED PAINTED ALUMINUM LETTERS. EXTERIOR SIGNAGE WILL BE SUBMITTED SEPARATELY TO THE CITY OF HUDSON FOR APPROVAL. INSTALLATION TO OCCUR AS PART OF CONSTRUCTION.

RESTROOM PLUMBING, EQUIPMENT, & ACCESSORIES:

TAG	ITEM	MOUNTING HEIGHT	REMARKS
1	ADA GRAB BAR MANUF. BRIZO STYLE: DECORATIVE ADA COMPLIANT EUROPEAN ROUND GRAB BAR	REFER TO SHEET G0.20	PROVIDE BLOCKING IN WALL AS REQ'D SEE SHEET G0.20 FOR TYPICAL MOUNTING HEIGHTS, SIZES, AND LOCATIONS. CONFIRM FINISH WITH OWNER.
2	TOILET PAPER DISPENSER MANUF. BOBRICK STYLE: B-6867 SURFACE MOUNTED DISPENSER COLOR: SATIN STAINLESS STEEL	24" A.F.F. TO C.L.	PROVIDE BLOCKING IN WALL AS REQ'D
3	SANITARY NAPKIN DISPOSAL MANUF. BOBRICK STYLE: B-270 CONTURA SERIES SURFACE MOUNTED DISPOSAL COLOR: STAIN STAINLESS STEEL	24" A.F.F. TO C.L.	PROVIDE BLOCKING IN WALL AS REQ'D
4	SHELF MANUF. AMERICAN SPECIALTIES, INC. STYLE: 20692-618 SURFACE MOUNTED SHELF 18" L X 6" D COLOR: 304 STAINLESS STEEL	30" A.F.F.	MOUNT ABOVE TOILET PAPER DISPENSER PROVIDE BLOCKING IN WALL IF REQ'D
5	PAPER TOWEL DISPENSER MANUF. BOBRICK STYLE: B-38034 TRIM LINE SERIES RECESSED DISPENSER COLOR: SATIN STAINLESS STEEL	44" A.F.F. TO TOWELS	PROVIDE BLOCKING IN WALL IF REQ'D
6	MIRROR CONFIRM SPECIFICATION FOR VANITY MIRROR WITH OWNER	40" MAX A.F.F. PER ADA	CENTER MIRROR ABOVE CENTER OF SINK/FAUCET PROVIDE BLOCKING IN WALL IF REQ'D
7	FULL LENGTH MIRROR CONFIRM SPECIFICATION FOR FULL HEIGHT WALL MIRROR WITH OWNER	TOP TO ALIGN WITH VANITY MIRROR	PROVIDE BLOCKING IN WALL IF REQ'D
8	WALL HOOK MANUF. OUTWATER PLASTICS INC. STYLE: HJT-22 COLOR: 304 SATIN STAINLESS STEEL	54" A.F.F.	

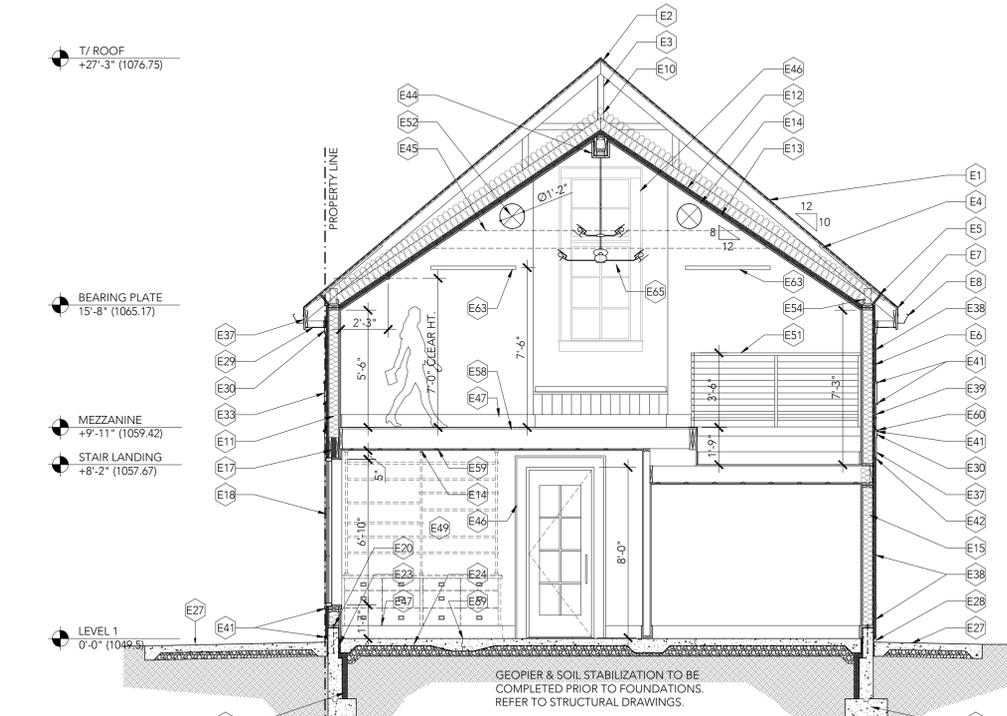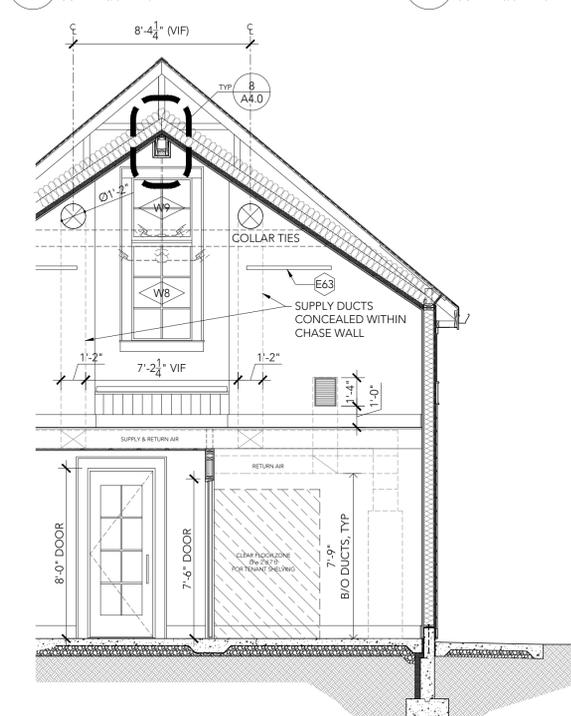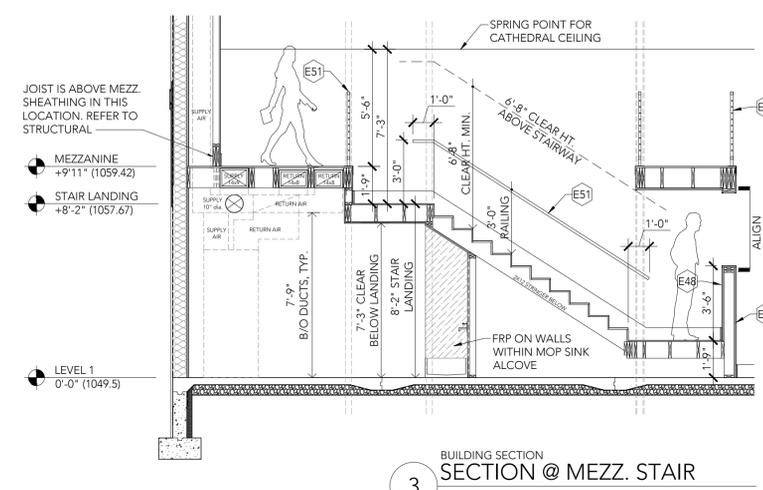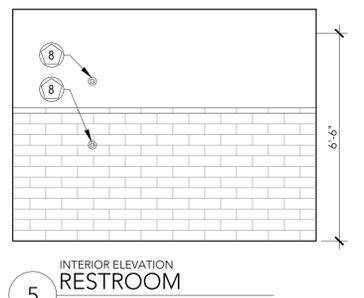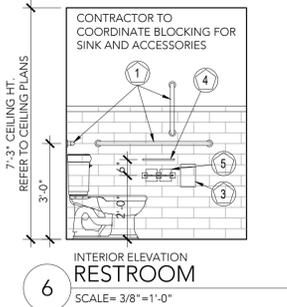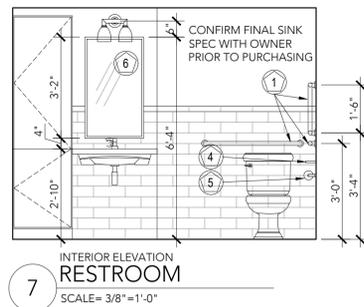

PROJECT INFORMATION

PROPOSED NEW CONSTRUCTION:  
**SMITHS CURATED BLDG.**  
48 CLINTON STREET  
HUDSON, OH 44236

GA PROJECT NO. 2020.013

ISSUED FOR PERMIT / BID



DATE  
JEFFREY W GIBBON OH LICENSE: ARC.1416217  
EXPIRATION 12/31/2021

DRAWING ISSUE RECORD  
DATE TITLE  
2021-0514 PERMIT / BID SET

REVISION SCHEDULE  
NO. DATE DESCRIPTION

SHEET DATE 05/14/2021  
ISSUED FOR PERMIT / BID

SHEET TITLE  
**CONSTRUCTION  
BUILDING SECTIONS**

SHEET NO.

**A3.51**

LEGEND

- INDICATES DETAIL OR PLAN NUMBER  
-INDICATES DWG SHEET NUMBER
- INDICATES ELEVATION NUMBER  
-INDICATES DWG SHEET NUMBER
- INDICATES SECTION NUMBER  
-INDICATES DWG SHEET NUMBER
- INDICATES KEY NOTE NUMBER  
(SEE KEY NOTE LEGEND, THIS SHEET)
- INDICATES ACCESSORY KEY NOTE  
(SEE LEGEND ON SHEET A3.51)
- INDICATES ELEVATION HEIGHT

KEY NOTES: ELEVATION/SECTION

- GENERAL NOTES**
- REFER TO GENERAL NOTES AS WELL AS KEY NOTES ON ARCHITECTURAL PLANS. CONTRACTOR IS RESPONSIBLE TO COORDINATE BETWEEN INFORMATION ON ALL CONTRACT DOCUMENTS INCLUDING THE ARCHITECTURAL AND ENGINEERING DRAWINGS, AND INFORMATION PROVIDED BY THE OWNER AND INTERIOR DESIGNER.
  - REFER ALSO TO FIXTURE LEGEND ON A3.51 & FINISH LEGEND ON A3.52.
  - ITEMS NOTED AS "OWNER PROVIDED" WILL BE SPECIFIED AND PURCHASED BY OWNER AND/OR INTERIOR DESIGNER. GC TO INSTALL. GC TO COORDINATE DELIVERY, INSTALLATION, AND LOGISTICS WITH OWNER.
- KEY NOTES: ELEVATION/SECTION**
- ASPHALT SHINGLE (CERTAINTED LANDMARK PRO, MAX DEF MOIRE BLACK) ON SYNTHETIC UNDERLAYMENT ON 1/2" APA RATED SHEATHING. NO SUBSTITUTIONS.
  - CONTINUOUS RIDGE VENT, TO MATCH ROOFING FINISH.
  - FABRICATED SCISSOR TRUSS. 10:12 TOP CHORD, 8:12 BOTTOM CHORD. SIZE & LAYOUT BY TRUSS MANUFACTURER. PROVIDE SHOP DRAWINGS PRIOR TO FABRICATION. REFER TO STRUCTURAL DRAWINGS FOR ADDITIONAL INFORMATION. COORDINATE INSTALLATION OF SCISSOR TRUSSES TO ALLOW FOR COLLAR TIE SPACING AS SHOWN ON A7.01.
  - ATTIC VENTILATION BAFFLE (1" MIN. DEPTH) ATTACHED TO ROOF SHEATHING ABOVE.
  - CLOSURE CAP: 1" RIGID INSULATION (R-5) BTWN. ROOF JOISTS & ROUGH CUT AROUND RAFTER VENT. SEAL PERIMETER WITH EXPANDING FOAM SEALANT.
  - 1" CONTINUOUS RIGID INSULATION (R-5) OVER CONTINUOUS FULLY

- ADHERED VAPOR BARRIER. EXTEND RIGID INSULATION TO TOP PLATE. RODENT PROTECTION CAP AT BASE.
- METAL DRIP EDGE.
- 6" K STYLE GUTTER, GUTTER COLOR TO MATCH TRIM.
- DOWNSPOUT, 3" x 4". REFER TO PLUMBING AND CIVIL DRAWINGS.
- 10.25" HIGH DENSITY "CATHEDRAL" FIBERGLASS BATT INSULATION (R-38 MIN.)
- 5.25" UNFACED HIGH DENSITY FIBERGLASS BATT INSULATION (R-21)
- 2" FOIL FACED POLYISO INSULATION (R-13) FASTENED TO UNDERSIDE OF TRUSS CHORD. TAPE SEAMS
- 3/4" FURRING STRIPS
- 3/8" GYPSUM WALL BOARD, LEVEL 5 FINISH, PAINTED
- 5/8" APA RATED SHEATHING, EA. SIDE OF 2x6 STUDS @ 16" O.C.
- 5/8" APA RATED SHEATHING, EA. SIDE OF 2x8 STUDS @ 16" O.C.
- SEE STRUCTURAL FOR BEAM/HEADER SCHEDULE. RIGID INSULATION BETWEEN HEADERS, WHERE APPLICABLE
- PELLA IMPERVIA WINDOW. DIRECT SET, FIXED WINDOW. APPLIED GRILLES (ALUM. D51, 1/2"), BOTH SIDES. BLACK FINISH BOTH SIDES
- PELLA RESERVE COMMERCIAL ENTRY DOOR. APPLIED GRILLES AND BLACK FINISH BOTH SIDES
- CONTINUOUS 2x6 TREATED PLATE WITH 3/8" DIA. ANCHOR BOLTS @ 32" O.C. SEE STRUCTURAL FOR DETAIL
- CONCRETE FOUNDATION, FOOTING & GEOPIERS. SEE STRUCTURAL FOR DETAIL
- 3" RIGID INSULATION (R-15) CONTINUOUS AT INSIDE FACE OF FOUNDATION

- 1" ISO BOARD AT SLAB EDGE. BACKER ROD AND SEAL
- EXPOSED AND FINISHED CONCRETE SLAB ON GRADE OVER 6 MIL VAPOR BARRIER (CONTINUE UNDER ENTIRE SLAB) OVER 6" GRANULAR FILL. SEE STRUCTURAL FOR SPECIFICATIONS AND DETAILS. SEE FINISH LEGEND FOR FINISH INFORMATION.
- 6" AIR SPACE
- FROST SLAB. SEE STRUCTURAL
- SLOPE SIDEWALK 1/4":1" AWAY FROM BUILDING. MAX. 2% CROSS SLOPE. SEE CIVIL
- MAINTAIN MIN. 2" CLEARANCE FROM GRADE TO FIBER CEMENT BOARD, TYP. IN ALL LOCATIONS
- FIBER CEMENT VENTED SOFFIT BOARD. 1/2" x 12" SMOOTH
- FIBER CEMENT TRIM BOARD. 3/4" x 3.5" SMOOTH
- FIBER CEMENT TRIM BOARD. 3/4" x 5.5" SMOOTH
- FIBER CEMENT TRIM BOARD. 3/4" x 7.25" SMOOTH
- FIBER CEMENT TRIM BOARD. 3/4" x 11.25" SMOOTH
- FIBER CEMENT TRIM BOARD. 3/4" x 5.5" SMOOTH
- FIBER CEMENT TRIM BOARD. 3/4" x 7.25" SMOOTH
- FIBER CEMENT TRIM BOARD. 3/4" x 9.25" SMOOTH
- FIBER CEMENT TRIM BOARD. 3/4" x 11.25" SMOOTH
- FIBER CEMENT SMOOTH PANEL BOARD
- FIBER CEMENT, V-GROOVE ASPYRE ARTISAN. 1/2" x 7" EXPOSURE
- 2x2 EXTERIOR TRIM
- 1x2 EXTERIOR TRIM
- 1/2" x 2 EXTERIOR TRIM

- 1x1 EXTERIOR TRIM
- DECORATIVE WOOD RIDGE BEAM. PRE-FABRICATED AND PRE-FINISHED. REFER TO 8/A4.00.
- DECORATIVE WOOD COLLAR TIE/BREAM. PRE-FABRICATED AND PRE-FINISHED. REFER TO 7/A4.00.
- 1x6 WOOD CASING, W/ 1" EDGE MOLDING, TYP. PAINTED
- WOOD BASE. SQ. EDGE. PAINTED. SEE FINISH LEGEND.
- 1x6 TONGUE & GROOVE WOOD PANELING, BOTH SIDE OF WALL, PAINTED. WOOD CAP. SEE FINISH LEGEND.
- BUILT-IN MILLWORK. OWNER PROVIDED. COORDINATE, BLOCKING, POWER & LIGHTING, CONTROLS LOCATIONS.
- RECESSED WALL MOUNTED KNOXBOX MODEL 3270, DARK BRONZE
- METAL GUARD & STAIR HAND RAILS. PROVIDE SLEEVE/PLATE CONNECTIONS AT SUPPORT POSTS. OWNER PROVIDED. PRE-FINISHED AT SHOP. SHOP DRAWINGS TO BE PROVIDED BY VENDOR TO ARCHITECT AND GC.
- SPIRAL SUPPLY DUCT. PAINT TO MATCH CEILING. SEE MECHANICAL
- 2x6 OUTLOOKERS @ 24" O.C. SEE STRUCTURAL
- SIMPSON TIE. SEE STRUCTURAL
- 2x10 WOOD RAFTERS @ 16" O.C. SEE STRUCTURAL
- 2x6 WOOD JOISTS @ 16" O.C.
- 6x6 TREATED WOOD POSTS. SIMPSON POST CAP AND BASE, TYP.
- 3/4" PLYWOOD SUB-FLOOR ON 2x12 WOOD JOISTS @ 16" O.C., DBL. EVERY OTHER. SEE STRUCTURAL
- RESILIENT CHANNELS @ 16" O.C. AT RIGHT ANGLE TO JOISTS. TYPE S/W SCREW ATTACHMENTS TO JOISTS
- METAL FLASHING


- 3/4" GLASS-MAT PANELS, TYPE X
- ROOF MEMBRANE FULLY ADHERED TO COVERBOARD ON TWO LAYERS. BUILT-UP INSULATION. STAGGER JOINTS HORIZONTALLY & VERTICALLY. SLOPE TO DRAIN AT 1/4":1". 6" THICKNESS (R-30) MIN.
- DISPLAY REVEAL A1025 BY "AS HANGING DISPLAY SYSTEM". FULLY RECESSED/CONCEALED FLANGE WALL MOUNT GALLERY ALUMINUM TRACK. MATCH COLOR TO BE WHITE. ANCHOR TO STUDS AND BLOCKING PER INSTALLATION SPECIFICATIONS. CONFIRM FINAL MOUNTING HEIGHTS IN FIELD WITH OWNER.
- CEILING FAN, OWNER PROVIDED. SEE MECHANICAL.
- DECORATIVE LIGHT FIXTURE. OWNER PROVIDED. SEE ELECTRICAL.
- EXTERIOR WALL SCONCE. SEE ELECTRICAL
- EXTERIOR SIGN LIGHT. SEE ELECTRICAL
- EXTERIOR GFCI RECEPTACLES. SEE ELECTRICAL
- CONSTRUCTION JOINT.
- CONTINUOUS METAL CURTAIN TRACK. OWNER PROVIDED. COORDINATE INSTALLATION WITH OWNER. CURTAINS PROVIDED BY OWNER.
- EXTERIOR METAL BUILDING SIGN, INTERNALLY HALO LIT. INDIVIDUALLY MOUNTED PAINTED ALUMINUM LETTERS. EXTERIOR SIGNAGE WILL BE SUBMITTED SEPARATELY TO THE CITY OF HUDSON FOR APPROVAL. INSTALLATION TO OCCUR AS PART OF CONSTRUCTION.

FINISH LEGEND & INFORMATION


FLOORING	WALLS	TILE
<b>CPT-1</b> TYPE: CARPET (BROADLOOM) MANUF: STYLE: COLOR: LOCATION: MEZZANINE & STAIRS NOTE: CONFIRM SPEC WITH OWNER	<b>PT-1</b> TYPE: FIELD PAINT COLOR MANUF: SHERWIN WILLIAMS COLOR: SELECTED BY OWNER FINISH: SELECTED BY OWNER	<b>WT-1</b> TYPE: MARBLE TILE MANUF: STYLE: COLOR: SIZE: INSTALL: GROUT: NOTE: SELECTED BY OWNER PROVIDED BY OWNER REFER TO BATHROOM ELEVATIONS
<b>CONC-1</b> TYPE: FINISHED CONCRETE FLOOR FINISH: MECHANICALLY TROWELLED NOTE: CAULK WITHIN RELIEF JOINTS APPLY SEALER	<b>PT-2</b> TYPE: FIELD PAINT COLOR MANUF: SHERWIN WILLIAMS COLOR: SELECTED BY OWNER FINISH: SELECTED BY OWNER	<b>FRP-1</b> FRP TYPE: WALL PANELS MANUF: MARLITE SPEC: S490N COLOR: LIGHT GREY S25
<b>CONC-1</b> TYPE: FINISHED CONCRETE FLOOR FINISH: BURNISHED FINISH NOTE:	<b>PT-3</b> TYPE: FIELD PAINT COLOR MANUF: SHERWIN WILLIAMS COLOR: SELECTED BY OWNER FINISH: SELECTED BY OWNER	
<b>WB-1</b> WALL BASE TYPE: WOOD WALL BASE COLOR: PAINTED TO MATCH WALL COLOR FINISH: SEMI-GLOSS SIZE: 1"XB" FLAT STOCK, SQUARE EDGES NOTE: USED IN ALL ROOMS, UNLESS NOTED	<b>PT-4</b> TYPE: TRIM PAINT COLOR MANUF: SHERWIN WILLIAMS COLOR: SELECTED BY OWNER FINISH: SELECTED BY OWNER	
<b>T&amp;G</b> TYPE: WOOD T&G EXTERIOR SOFFIT COLOR: SELECTED BY OWNER FINISH: SEMI-GLOSS SIZE: 6" WIDE WOOD PLANKS	<b>PT-5</b> TYPE: TRIM PAINT COLOR MANUF: SHERWIN WILLIAMS COLOR: SELECTED BY OWNER FINISH: SELECTED BY OWNER	
	<b>PT-6</b> TYPE: EXTERIOR SIDING PAINT COLOR MANUF: SHERWIN WILLIAMS COLOR: SELECTED BY OWNER FINISH: SELECTED BY OWNER	
	<b>PT-7</b> TYPE: EXTERIOR TRIM PAINT COLOR MANUF: SHERWIN WILLIAMS COLOR: SELECTED BY OWNER FINISH: SELECTED BY OWNER	
	<b>PT-8</b> TYPE: EXTERIOR SOFFITS PAINT COLOR MANUF: SHERWIN WILLIAMS COLOR: SELECTED BY OWNER FINISH: SELECTED BY OWNER	

FINISH NOTES


- DRYWALL FINISH (WALLS AND CEILINGS):  
 LEVEL 5: MAIN SHOWROOM AND MEZZANINE AREA  
 LEVEL 4: RESTROOM, UTILITY ROOM
- REFER TO INTERIOR ELEVATIONS FOR RECESSED PICTURE RAIL LOCATIONS.
- ALL MILLWORK PROVIDED BY OWNER. CONTRACTOR TO COORDINATE POWER ROUGH-IN, BLOCKING REQUIREMENTS, AND INSTALLATION.
- METAL HANDRAIL AND GUARDRAILS PROVIDED BY OWNER. CONTRACTOR TO COORDINATE BLOCKING AND INSTALLATION.
- PROVIDE BLOCKING AS REQ'D FOR ALL RESTROOM ACCESSORIES AND GRAB BARS.
- ALL EXTERIOR CEMENTITIOUS SIDING AND TRIM TO BE PRE-PRIMED, FIELD PAINTED.
- ALL FINISHES TO COMPLY WITH OBC, CHAPTER 8

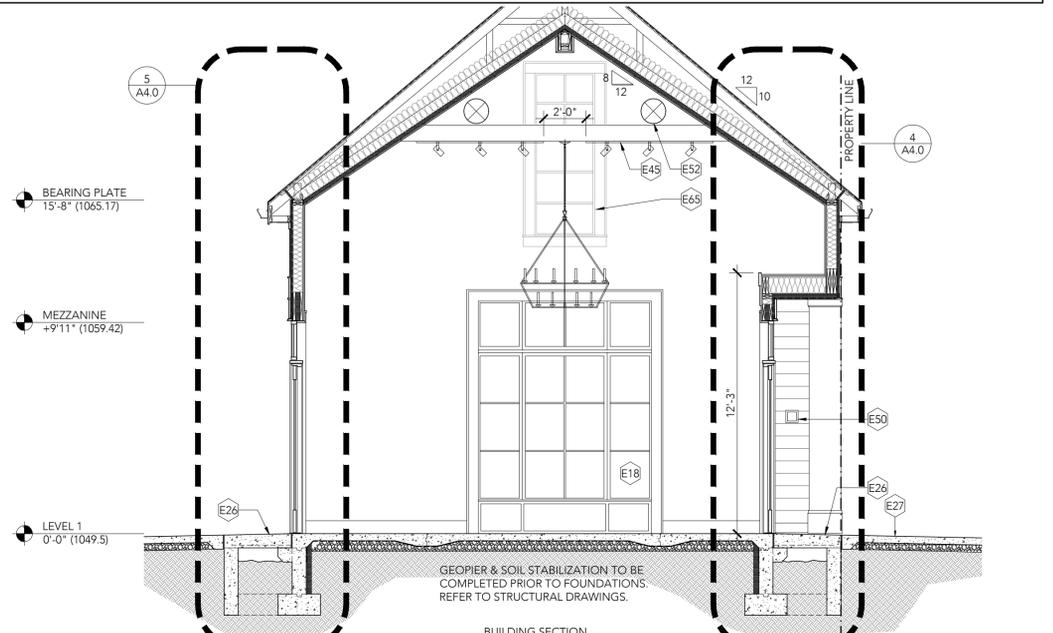

3 BUILDING SECTION  
FACING WEST @ ENTRIES  
SCALE: 1/4" = 1'-0"

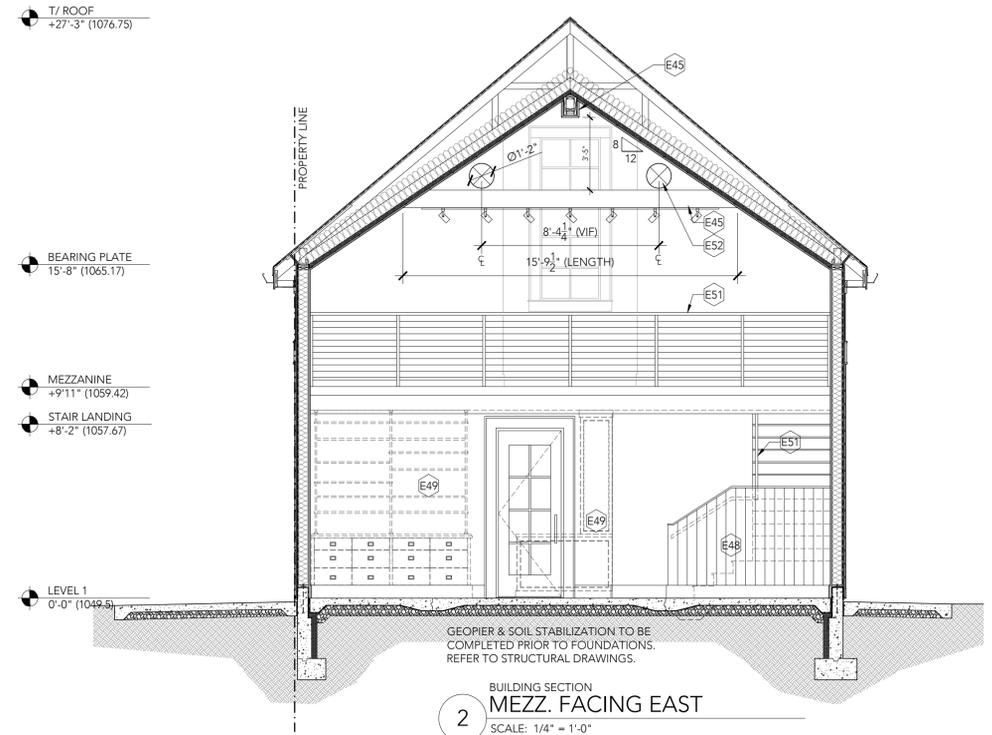

2 BUILDING SECTION  
MEZZ. FACING EAST  
SCALE: 1/4" = 1'-0"

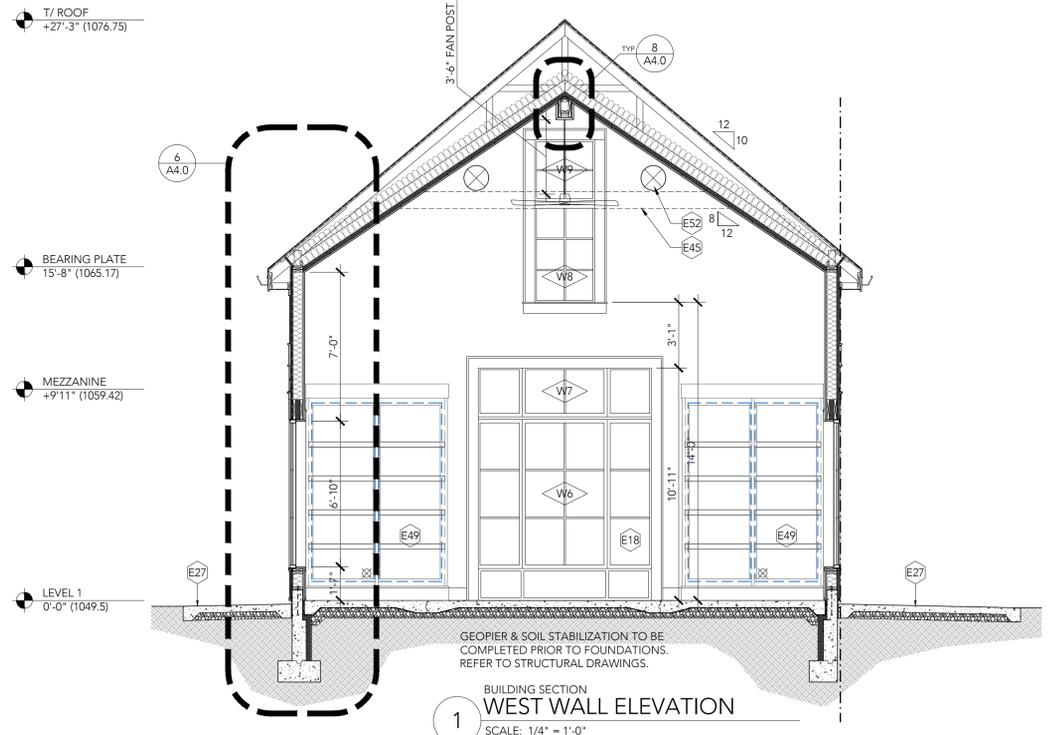

1 BUILDING SECTION  
WEST WALL ELEVATION  
SCALE: 1/4" = 1'-0"



PROJECT INFORMATION

PROPOSED NEW CONSTRUCTION:  
**SMITHS CURATED BLDG.**  
 48 CLINTON STREET  
 HUDSON, OH 44236

GA PROJECT NO. 2020.013

ISSUED FOR PERMIT / BID

PROFESSIONAL SEAL



DATE: JEFFREY W GIBBON OH LICENSE: ARC.1416217 EXPIRATION 12/31/2021

DATE	TITLE
2021-0514	PERMIT / BID SET

NO.	DATE	DESCRIPTION
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SHEET DATE: 05/14/2021  
 ISSUED FOR PERMIT / BID

SHEET TITLE:  
**CONSTRUCTION BUILDING SECTIONS & FINISH LEGEND**

SHEET NO.

A3.52



ASPYRE  
COLLECTION  
by **JamesHardie** <sup>TM</sup>

Distinctive design that's engineered to last

Product Catalog

INTRODUCING THE  
ASPYRE COLLECTION  
BY JAMES HARDIE™



*artisan* + REVEAL  
Siding | Trim™ Panel System™

Craft one-of-a-kind homes by integrating contrasting elements using the Aspyre Collection by James Hardie™. Ever-changing shadow lines cast by Artisan® siding add warmth to the fixed geometry of smooth Reveal® Panels.

### Contents

Introduction	2-3
Performance	4-5
Artisan® Siding and Trim	6-15
Reveal® Panel System	16-19



Artisan® V-Groove Siding

# PERFORMANCE

THROUGH INNOVATION

The Aspyre Collection features the uncompromising performance you've come to expect from James Hardie.

## JAMES HARDIE® FIBER CEMENT IS TOUGHER THAN THE ELEMENTS

Artisan® and Reveal® products are uniquely Engineered for Climate® – specifically designed to resist the effects of your local weather conditions.



Stands up to storms and harsh weather



Water resistant to help protect against swelling and mold damage



Won't be eaten by animals or insects



Fire resistant

# artisan

Siding | Trim™

RETHINK  
THE CLASSICS

Artisan® Lap Siding

OHIO  
HUDSON  
COMMUNITY DEVELOPMENT  
DEPARTMENT

✓ Approved

Reviewed by Nick Sugar  
09/09/2020, 9:17:22 PM

## Thick Artisan® siding

casts gorgeous shadow lines, recreating milled cedar profiles with lower maintenance.

## Lock Joint System



helps enable faster, cleaner installation. Orient vertically, horizontally or use as soffit.


## Tongue and Groove System

saves time on installation while providing a precise fit and seamless look.

## Mitered corners

add sophistication to your design and can be crafted on-site with any Artisan® profile.

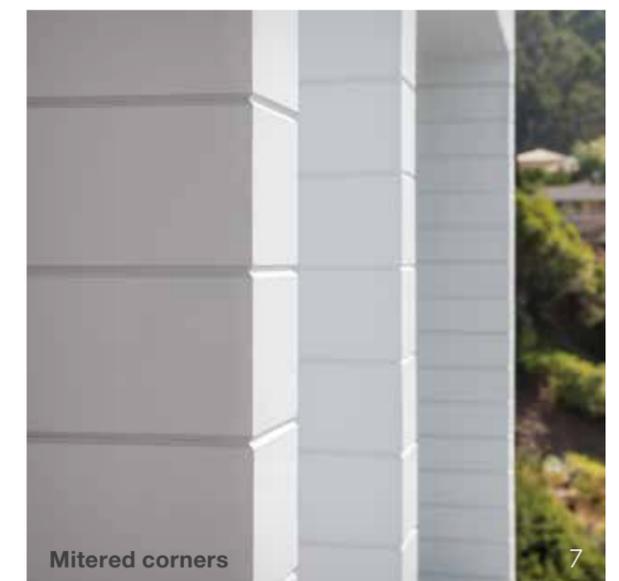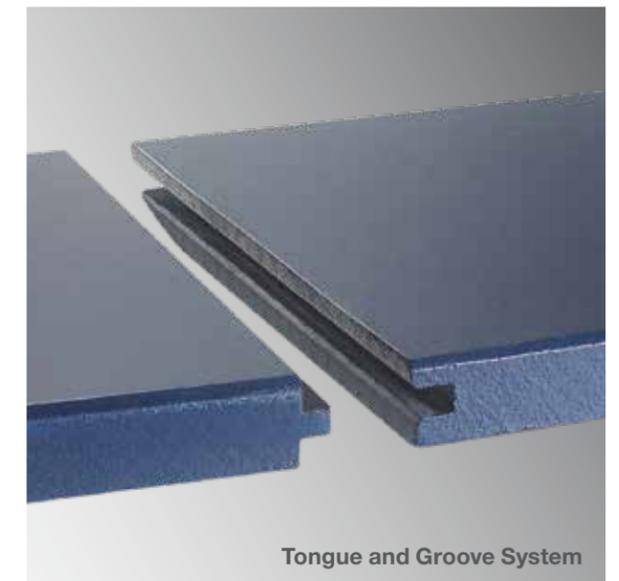


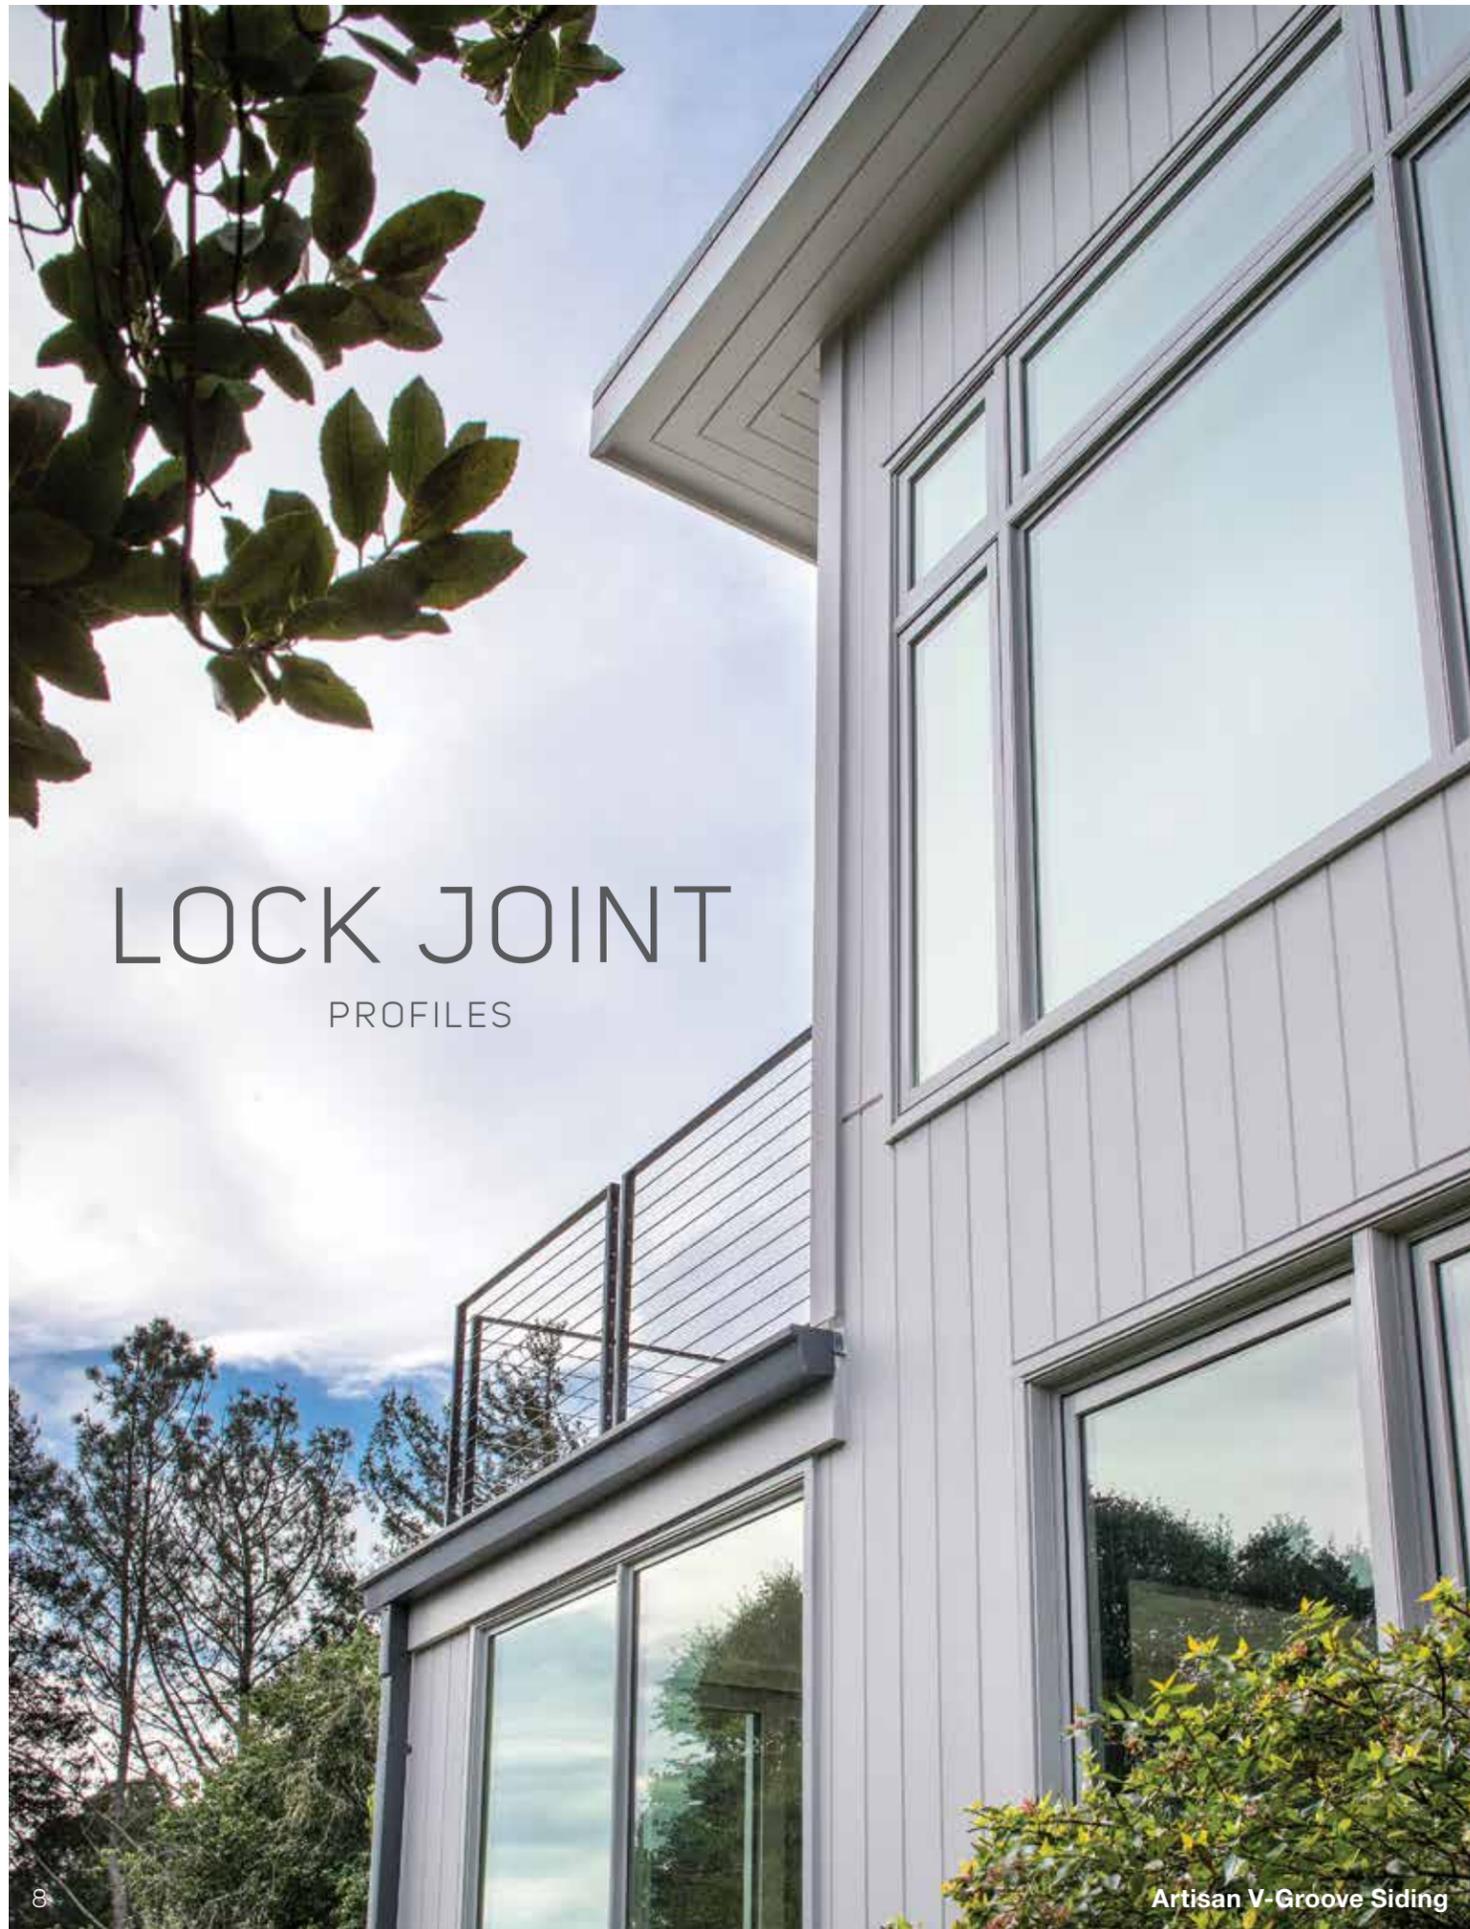

# LOCK JOINT

PROFILES

Artisan V-Groove Siding

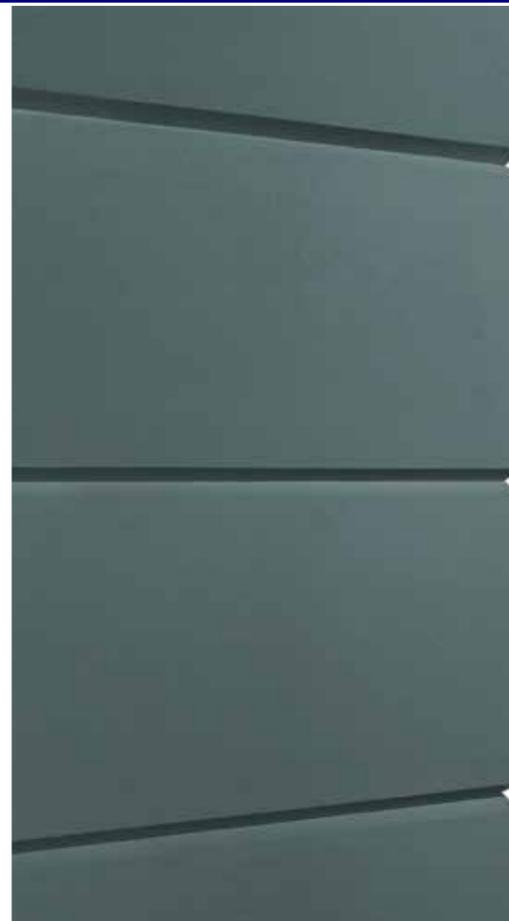

## ARTISAN® V-GROOVE SIDING

- Deep v-shaped channels
- Great for vertical, horizontal and soffit applications

WIDTH  
8.25 in  
(7.0 in Exposure)

THICKNESS  
5/8 in

TEXTURE  
Smooth

FINISH  
Primed

PROFILE  
WIDTH x DEPTH  
0.5 in x 0.263 in



Approved

Reviewed by Nick Sugar  
09/09/2020, 9:17:28 PM

## ARTISAN® BEVEL CHANNEL SIDING

- Chiseled lines emphasize its deep channels
- Adds an upscale accent to every home

WIDTH  
10.25 in  
(9.0 in Exposure)

THICKNESS  
5/8 in

TEXTURE  
Smooth

FINISH  
Primed

PROFILE  
WIDTH x DEPTH  
1.68 in x 0.263 in



# ARTISAN® TRIM

- Perfect partner for Artisan® profiles
- Thick boards for distinctly deep shadow lines

WIDTH  
3.25 in  
and 5.5 in

THICKNESS  
1.5 in

WEIGHT  
4.55 lbs/sq ft

LENGTH  
144.0 in

FINISH  
Primed



Artisan Trim and  
Artisan V-Groove Siding



## SOPHISTICATED STYLING

### LOCK JOINT PROFILES



Artisan V-Groove



Artisan Bevel Channel



Artisan Shiplap



Artisan Square Channel

### TONGUE & GROOVE PROFILES



Artisan Lap



Artisan Beaded Lap

# REVEAL

Panel System™



SHAPE  
WHAT'S NEXT

The Reveal® Panel System expands modern design options with smooth, thick panels plus multiple trim and fastener products.



Reveal Panel and Reveal Recess Trim

## REVEAL® RECESS TRIM

- Provides clean, sharp shadow lines for a simple aesthetic
- Gives a sense of lightness to modern architecture



**Reveal Recess Trim**  
Available primed



**Reveal™ Countersunk Fasteners\***  
Compatible with primed panels

## REVEAL® SURROUND TRIM

- Boldly frames the smooth, flat Reveal Panel
- Accentuates the modern industrial look



**Reveal Surround Trim**  
Available primed in clear anodized finish or with ColorPlus® Technology finishes\*\*



**Reveal™ Exposed Fasteners\***  
Stainless steel  
Available in ColorPlus® Technology finishes\*\*

\*Can be used with either Reveal Recess Trim or Reveal Surround Trim.  
\*\*Talk to your local rep about ColorPlus Technology availability in your market.

# CREATIVITY IS IN THE DETAILS



Reveal Recess Trim



Reveal Surround Trim



Reveal Surround Trim



Reveal Exposed Fasteners



Reveal Countersunk Fasteners

Customizable system allows you to mix and match compatible components.



Reveal Panel and Reveal Surround Trim



Reveal Panel and Reveal Recess Trim

Reveal® Panel	
	Thickness 7/16 in Width 47.5 in Length 95.5 in  Available with ColorPlus® Technology finishes*
Reveal Fastening Products	
	<b>Countersunk Filler</b> Filler usage rate for countersunk fastening application, 1 box of filler per 1 pallet (40 sheets) of Reveal Panels
	<b>Countersinking Bit</b> Usage rate for countersunk fastening application, 1 unit per 1 pallet (40 sheets) of Reveal Panels
	<b>Countersunk Fasteners for Wood</b> 1 5/8 in length x 0.39 in HD, 316 SS, Bugle Head Square Drive
	<b>Countersunk Fasteners for Steel</b> 1 5/8 in length x 0.39 in HD, 410 SS, Bugle Head #2 Square Drive
	<b>Exposed Fasteners for Wood</b> 1.5 in length x 0.189 in x 0.472 in HD, 10-12 SS, T20W Torx Pan Head
	<b>Exposed Fasteners for Steel</b> 1.125 in length x 0.169 in x 0.472 in HD, T20W Torx Pan Head Self-Drilling

## ADD DEFINITION TO YOUR DESIGN

Reveal® Recess Trim Length 8 ft	Reveal® Surround Trim Length 8 ft
<b>Outside Corner Trim</b>	<b>Horizontal Trim</b>
<b>Horizontal Trim</b>	<b>Vertical Trim</b>
<b>Vertical Trim</b>	<b>Outside Corner Trim</b>
<b>Drainage Flashing Trim</b>	<b>Inside Corner Trim</b>
<b>Horizontal Edge Trim</b>	<b>J Channel Trim</b>
<b>Vertical F Trim</b>	<b>Drainage Flashing Trim</b>

\*Talk to your local rep about ColorPlus Technology availability in your market.

The Aspyre Collection by James Hardie™  
expands your creative possibilities



ASPYRE  
COLLECTION  
by JamesHardie™

[aspyredesign.com](http://aspyredesign.com)

Artisan V-Groove Siding  
and Artisan Lap Siding



Pella®  
Impervia®


Windows  
and Patio  
Doors




Photos: © VONDELINDE

Pella® Impervia® windows and patio doors are made from Duracast®, Pella's patented, five-layer engineered fiberglass composite material. Pella's AAMA 623 compliant, powder coat finish resists fading and scratching. Duracast has many characteristics that make it a good material for windows and patio doors:

- Low Thermal Conductance
- Low Thermal Expansion
- High Impact Resistance
- High Scratch Resistance

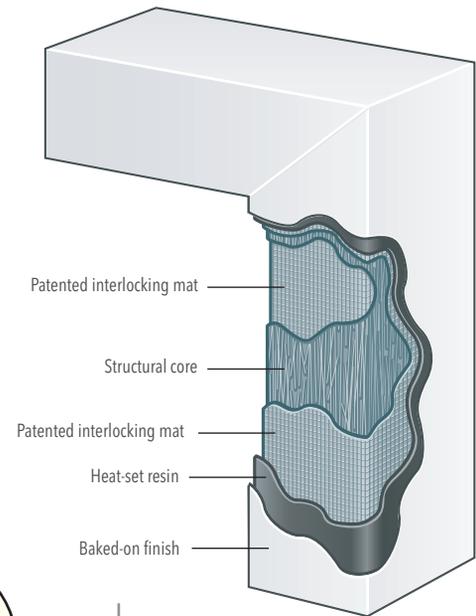


### Thermal Expansion

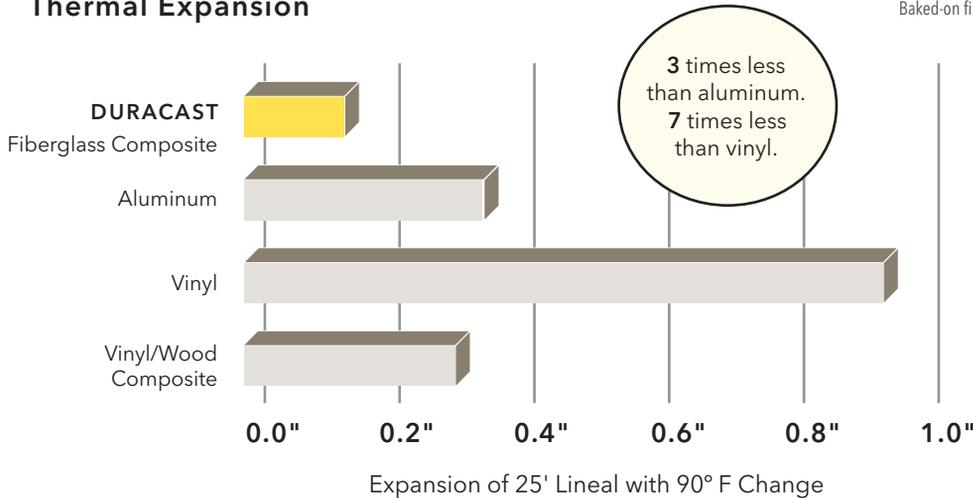

# Brand Overview

	Cross Section	Frame / Install	Wall Depth Range	Performance Range
Awning/ Casement Vent and Fixed		Block Frame Standard Fin Off-set fin Integral fin	Base Frame Depth: 3-1/4" Std. Fin Setback: 1-5/16" Base Wall Depth: 1-15/16" Jamb extended wall depth: 2-9/16" - 7-3/16"	LC30 - LC50 U: 0.24 - 0.34 SHGC: 0.18 - 0.55 STC: up to 33
Double-Hung Vent		Block Frame Standard Fin Off-set fin Integral fin	Base Frame Depth: 3" Std. Fin Setback: 1-5/16" Base Wall Depth: 1-11/16" Jamb extended wall depth: 2-9/16" - 7-3/16"	LC30 - LC50 U: 0.25 - 0.32 SHGC: 0.19 - 0.52 STC: up to 29
Single-Hung, Sliding Window & Fixed Sash in Frame		Block Frame Standard Fin Off-set fin Integral fin Flush Flange	Base Frame Depth: 3" Std. Fin Setback: 1-5/16" Base Wall Depth: 1-11/16" Jamb extended wall depth: 2-9/16" - 8-5/16"	CW50 U: 0.23 - 0.36 SHGC: 0.19 - 0.55 STC: up to 33
Fixed Frame Direct Set		Block Frame Standard Fin Off-set fin	Base Frame Depth: 3-1/4" Base Wall Depth: 1-15/16" Jamb extended wall depth: 2-9/16" - 7-3/16"	CW30 - CW50 U: 0.21 - 0.32 SHGC: 0.20 - 0.60 STC: up to 36
Sliding Patio Door		Block Frame	Base Frame Depth: 4-3/4"	LC30 - LC50 U: 0.25 - 0.33 SHGC: 0.19 - 0.54 STC: up to 32

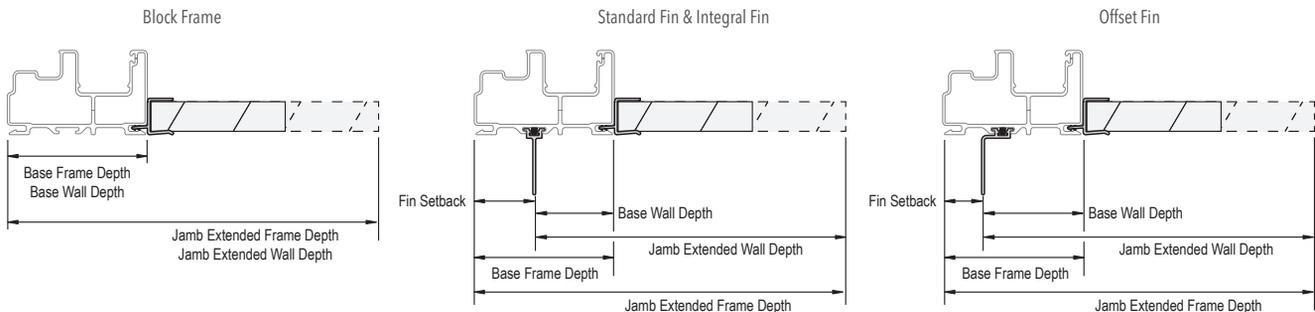

Jamb extensions are available as a field applied option only.

Performance ranges shown are for single-units and do not account for composite units (integral mullion) or combinations (multiple units mullied together).

Drawings are not to scale.

## Finishes

Pella Impervia products are factory pre-finished with powder-coat paint. This paint meets the stringent AAMA 623 standards. Powder-coat paint is resistant to dents, scratches and damaging UV light.

### Colors



White



Tan



Brown



Black



Morning Sky Gray

Optional Dual-color finish, white interior with your choice of available exterior colors, available on Block Frame units. Dual color is not available with integral nail fin.

## Hardware

Standard hardware finishes match the interior color of the unit with the same powder-coated paint finish, optional metal finishes include a coating to prevent oxidation or tarnishing.

### Casement/Awning Window Cranks <sub>1</sub>



White



Tan



Brown



Matte Black



Morning Sky Gray



Bright Brass



Satin Nickel



Oil-Rubbed Bronze

### Window Locks <sub>1</sub>



White



Tan



Brown



Matte Black



Morning Sky Gray



Bright Brass



Satin Nickel



Oil-Rubbed Bronze



Approved

Reviewed by Nick Sugar  
09/09/2020, 9:17:59 PM

### Sliding Patio Doors <sub>2</sub>



White



Tan



Brown



Matte Black



Morning Sky  
Gray



Bright Brass



Satin Nickel



Oil-Rubbed  
Bronze



Chrome



Antique Brass



Exterior <sub>2</sub>  
Handle with  
Keylock  
Option


(1) Standard lock hardware is finished to match the interior of the window or door frame.

(2) Finish of exterior hardware matches color of exterior door frame.



# Brand Overview

## Grilles-Between-The-Glass <sub>1</sub>

- Color matches frame.
- Grilles are 3/4" wide.
- Multiple grille patterns are available.
- Standard corner lite dimension for Prairie patterns = 4" visible glass (VG).
- Pattern availability may vary depending on size of unit.

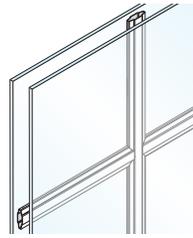


### Grille Profile

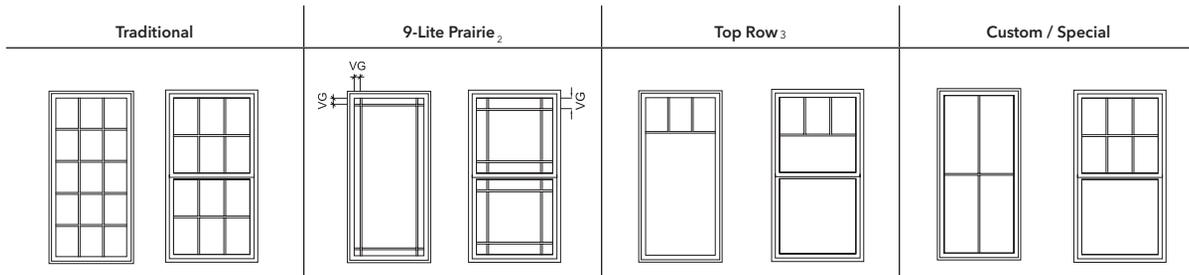
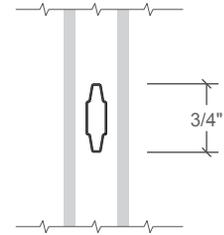


## Applied Grilles (Available on Fixed Frames Only)

- Grilles adhere to the exterior and interior faces.
- Color matches frame.
- Grilles are 1-5/8" wide to match frame width.
- Multiple grille patterns are available.
- Simulate multiple unit composites.

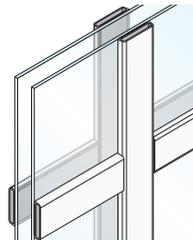

### Grille Profile

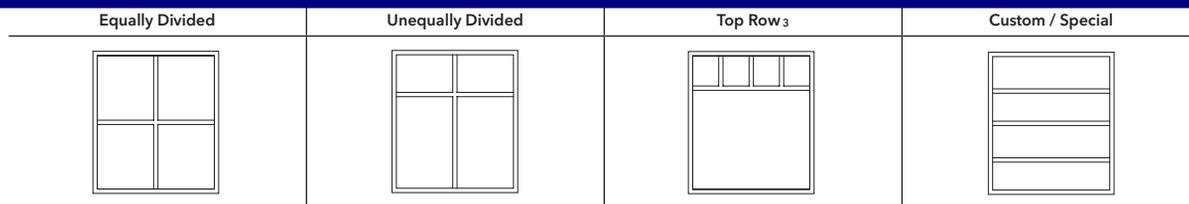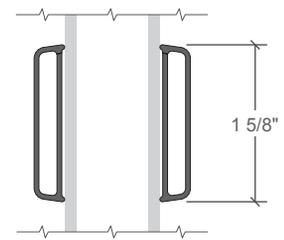

The above are examples only. Lite dimensions noted can vary.

(1) Appearance of exterior grille color may vary depending on the Low-E insulating glass selection.

(2) Standard Corner lite dimension for Prairie patterns = 4" visible glass (VG).

(3) Standard visible glass to center line of separator bar = 14" or half the total visible glass height, whichever is smaller. Multiple rows are available up to 50% glass size.

Pattern availability may vary depending on size of unit.

Custom configurations are also available, for details contact your local Pella sales representative.




Approved

Reviewed by Nick Sugar  
09/09/2020, 9:18:01 PM

# LANDMARK<sup>®</sup> PRO

The Expert's Choice

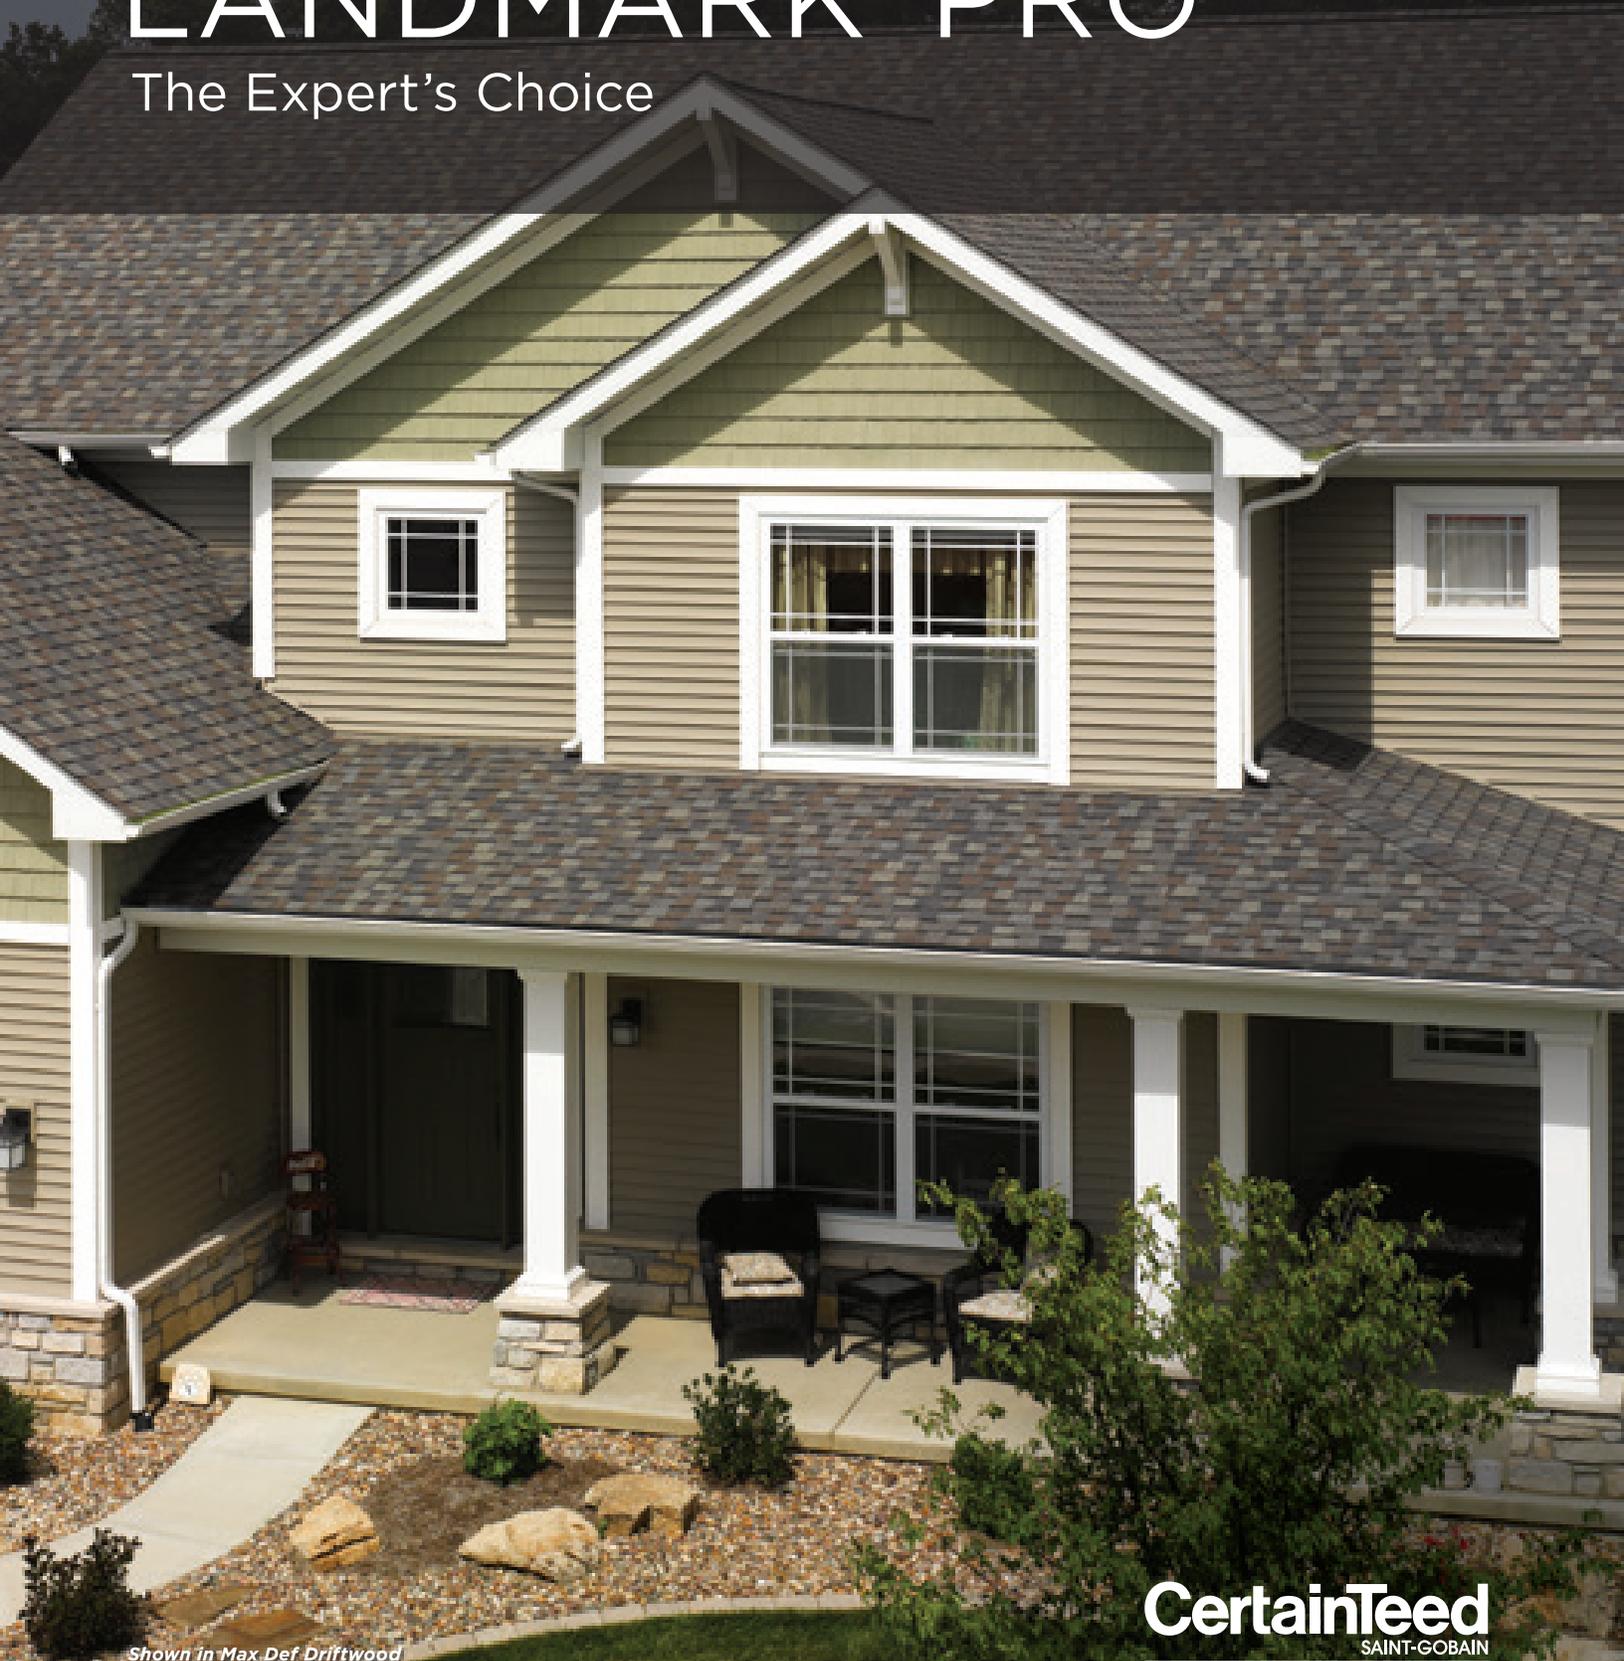

*Shown in Max Def Driftwood*

**CertainTeed**  
SAINT-GOBAIN

# Introducing More Value

Landmark® Pro is designed specifically for the professional roofing contractor that takes pride in providing more to their customer.

Landmark® Pro improves upon the CertainTeed Landmark shingle, a leading consumer publication's "Best Buy" for the past five years.

We started by adding more weathering asphalt to the industry's toughest fiberglass mat to provide more protection. Then we incorporated our Maximum Definition color blend technology to give the product more vibrancy on the roof. Included is the proven performance of our NailTrak™ feature, enabling faster installation.

Landmark Pro offers the industry's strongest warranty. Protecting your reputation and safeguarding homeowners from manufacturing and aesthetic defects.

## LANDMARK PRO STANDARD WARRANTY

- Lifetime Limited Warranty
- 10-years of SureStart™ protection
- 15-year 110 MPH wind warranty (Upgrade to 130 MPH available. CertainTeed starter and CertainTeed hip and ridge required.)
- 15-year StreakFighter® algae resistance warranty 

Add it all up and what you get is the opportunity to offer a lot of additional value for the money... and today that means more than ever.

## LANDMARK® PRO



### Landmark Pro specifications:

- Premium Max Def color palette
- NailTrak for faster installation
- Lifetime limited warranty
- 15-year algae resistance
- 10-year SureStart protection includes:
  - Materials, labor, tear off and disposal cost
- 15-year 110 MPH wind warranty with upgrade to 130 MPH available

## LANDMARK®



### Landmark specifications:

- Traditional color palette
- NailTrak for faster installation
- Lifetime limited warranty
- 10-year algae resistance
- 10-year SureStart protection includes:
  - Materials and labor costs
- 15-year 110 MPH wind warranty with upgrade to 130 MPH available

# LANDMARK® PRO COLOR PALETTE



Max Def Atlantic Blue



Max Def Burnt Sienna



Max Def Cobblestone Gray



Max Def Colonial Slate



Max Def Driftwood



Max Def Georgetown Gray



Max Def Heather Blend




Max Def Moiré Black



Max Def Pewter



Max Def Prairie Wood

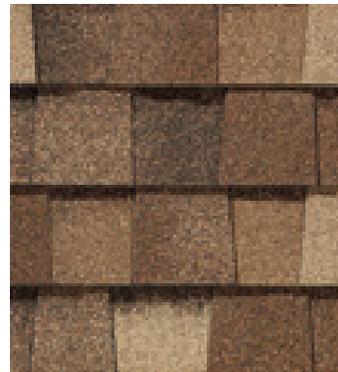

Max Def Resawn Shake



Max Def Shenandoah



Max Def Weathered Wood


## Max Def Colors

Look deeper. With Max Def, a new dimension is added to shingles with a richer mixture of surface granules. You get a brighter, more vibrant, more dramatic appearance and depth of color. And the natural beauty of your roof shines through.


# Wider. Faster. Proven.

For the past 10 years, NailTrak™ has enabled installers to shingle with improved speed and accuracy. With a nailing area that's three times WIDER than typical laminate shingles, nails hit home with NailTrak. A feature on all Landmark® Series shingles. Speed and accuracy result in lower labor costs.

**No leaks. No de-lamination. No callbacks.**  
**The cost of doing business has gone down with NailTrak.**

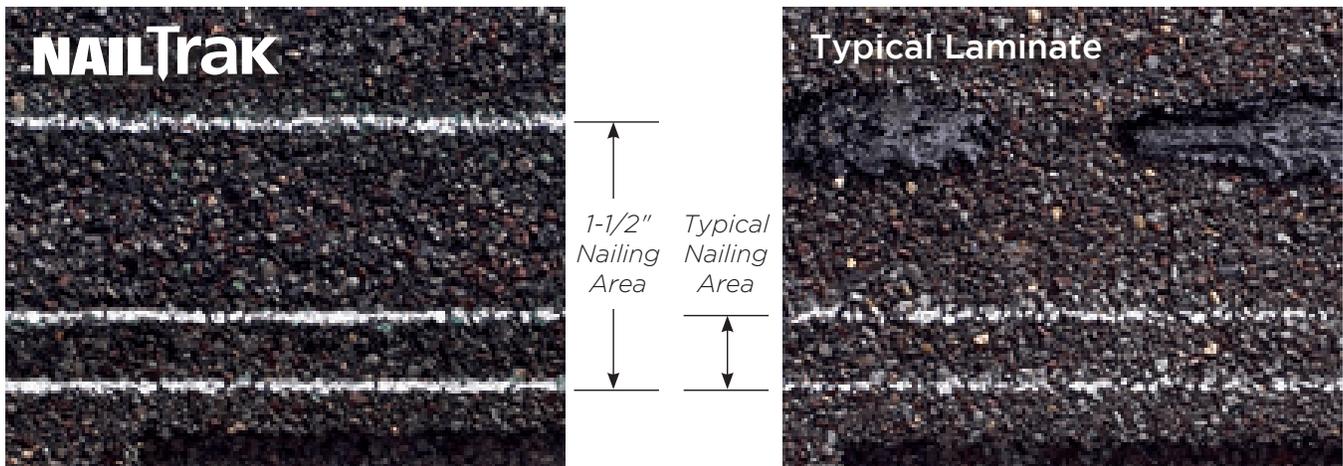


FRONT

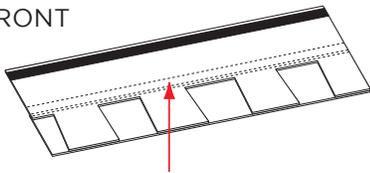


Wide nailing area for increased speed and accuracy.

BACK

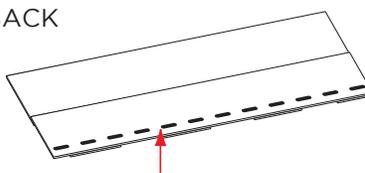

Sealant placed low to avoid gumming up nail guns.

UNDERSIDE OF TOP

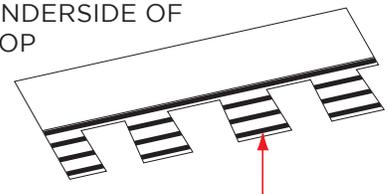

Specially formulated Quadra-Bond adhesive adheres the two-piece laminate shingle.

Landmark® Pro available in areas shown



learn more at: [certainteed.com/roofing](http://certainteed.com/roofing)



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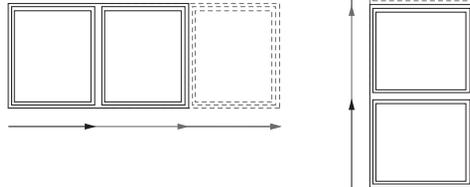
## Combination Assemblies

A combination is an assembly formed by two or more separate windows or doors whose frames are mullioned together by a combination or reinforcing mullion. A composite is an assembly of windows inside a single, continuous frame.


Pella Impervia products are available in an endless variety of configurations. Refer to the Product Application section of this book, [PellaADM.com](http://PellaADM.com) or your local Pella sales representative for information on performance and availability.

### Window Composite Examples

Fixed Frame



Single-Hung and fixed sash and frame

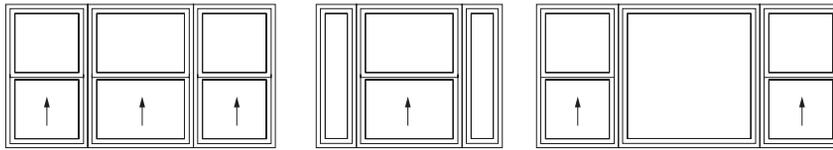

### Window Combination Examples

#### Factory Assembled Combination Parameters

144" x 105" max. overall frame size (block frame)\*.


144" x 100" max. overall frame size (nail fin and offset nail fin)\*.

Not available with integral flange frame.


Mullion reinforcing may be required to limit deflection to code requirements.

Frame depth cannot vary within rows and columns.


Double Hung windows cannot be placed above a 1/2" aluminum reinforcing mullion.

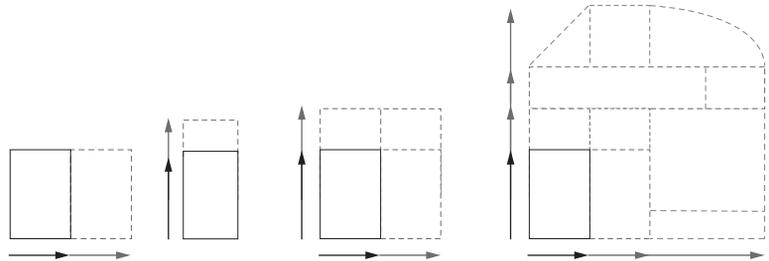

Bay/Bow

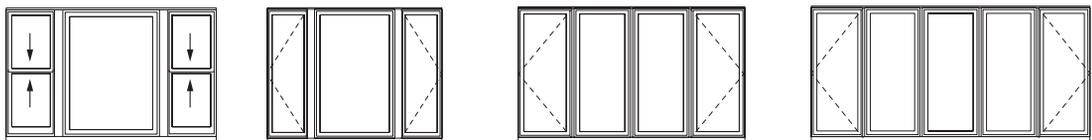

### Door and Window Combination Examples

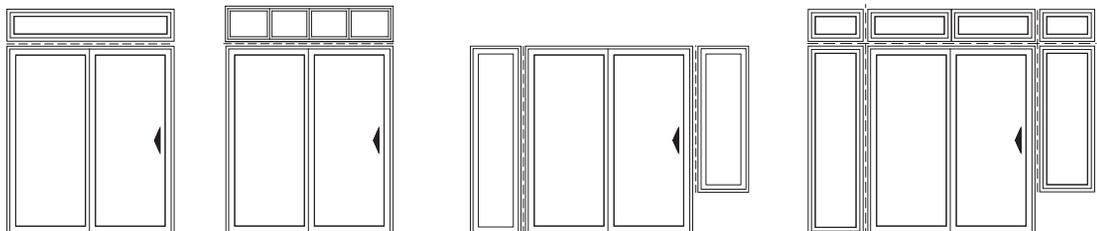

\*Actual mullion span and combination size availability depends on design pressure requirements. Consider combination size, weight and jobsite handling during design.