


LOT IMPROVEMENT PLAN

FOR MODERN HOME CONCEPTS SITUATED ON PARTS OF SUBLOT 2 AND SUBLOT 3 IN THE WESTERN RESERVE RANCH ESTATES PART 1. CITY OF HUDSON, SUMMIT COUNTY, STATE OF OHIO **APRIL**, 2018

ENLARGED GRADING PLAN: 1" = 30'

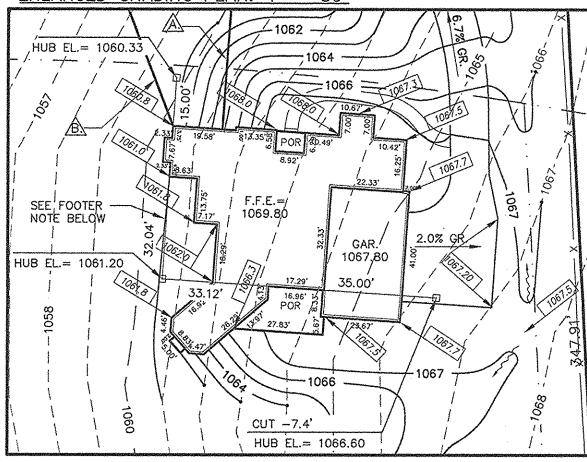

GENERAL CONSTRUCTION NOTES:

INSTALL NEW SANITARY WYE AT MAIN W/ AN INSERTA-TEE CONNECTION. EX. 8"FL.= 1049.5+/-. NEW 4"FL.= 1050.2+/-. INSTALL 130 L.F. - 4" SAN. CONN. @ 5.4%. PROP. 4"FL. @ HSE.= 1057.2.

PROP. 6" STM. @ HSE.= 1059.2. INSTALL 115 L.F. - 6" STM. @ 6.2%. PROP. 6"FL. @ OUTLET= 1052.0. INSTALL 8 L.F. 6" ROCK RIP-RAP PROTECTION.

FOOTER NOTE: FOOTERS SHALL BE DEEPENED WHERE NECESSARY TO MAINTAIN PROPER FROST PROTECTION.


PROP. RESIDENCE ELEVATIONS: GAR. FLR.= 1067.80 1st. FLR.= 1069.80 TOP/FDN.= 1068.84 BSMT FLR.= 1060.17 BOT. FOOTER= 1059.2

Rolling & Hocevar, Inc.

257 SOUTH COURT ST. SUITE 6 DATE 04/16/18 MEDINA, OHIO 44256 (330)723-1828 PROJ. No. 22,713 FAX (330)723-6637

THE CONTRACTOR/OWNER MUST VERIFY ALL FOUNDATION DIMENSIONS & PROPOSED GRADES SHOWN ON THIS TOPOGRAPHIC SURVEY. CUTS BETWEEN HUBS SHALL BE COMPARED FOR DISCREPANCIES. ANY ERROR RESULTING FROM FAILURE TO CHECK SHALL NOT BE THE RESPONSIBILITY OF ROLLING & HOCEVAR, INC.



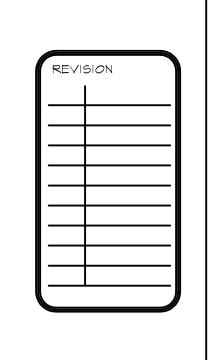

JOB DESCRIPTION
PROPOSED RESIDENCE FOR
FRIES RESIDENCE
7523 HUNTINGTON ROAD
HIDSON OHIO

77 CHURCH HILL COURT NOOSTER, OHIO 44691 (330) 464-3369


MODERN HOME CONCEPTS



DRAWING NUMBER

MHC063

PROPERTY OF MODERN HOME CONCEPTS. ANY REPRODUCTION WITHOUT WRITTEN PERMISSION IS PROHIBITED

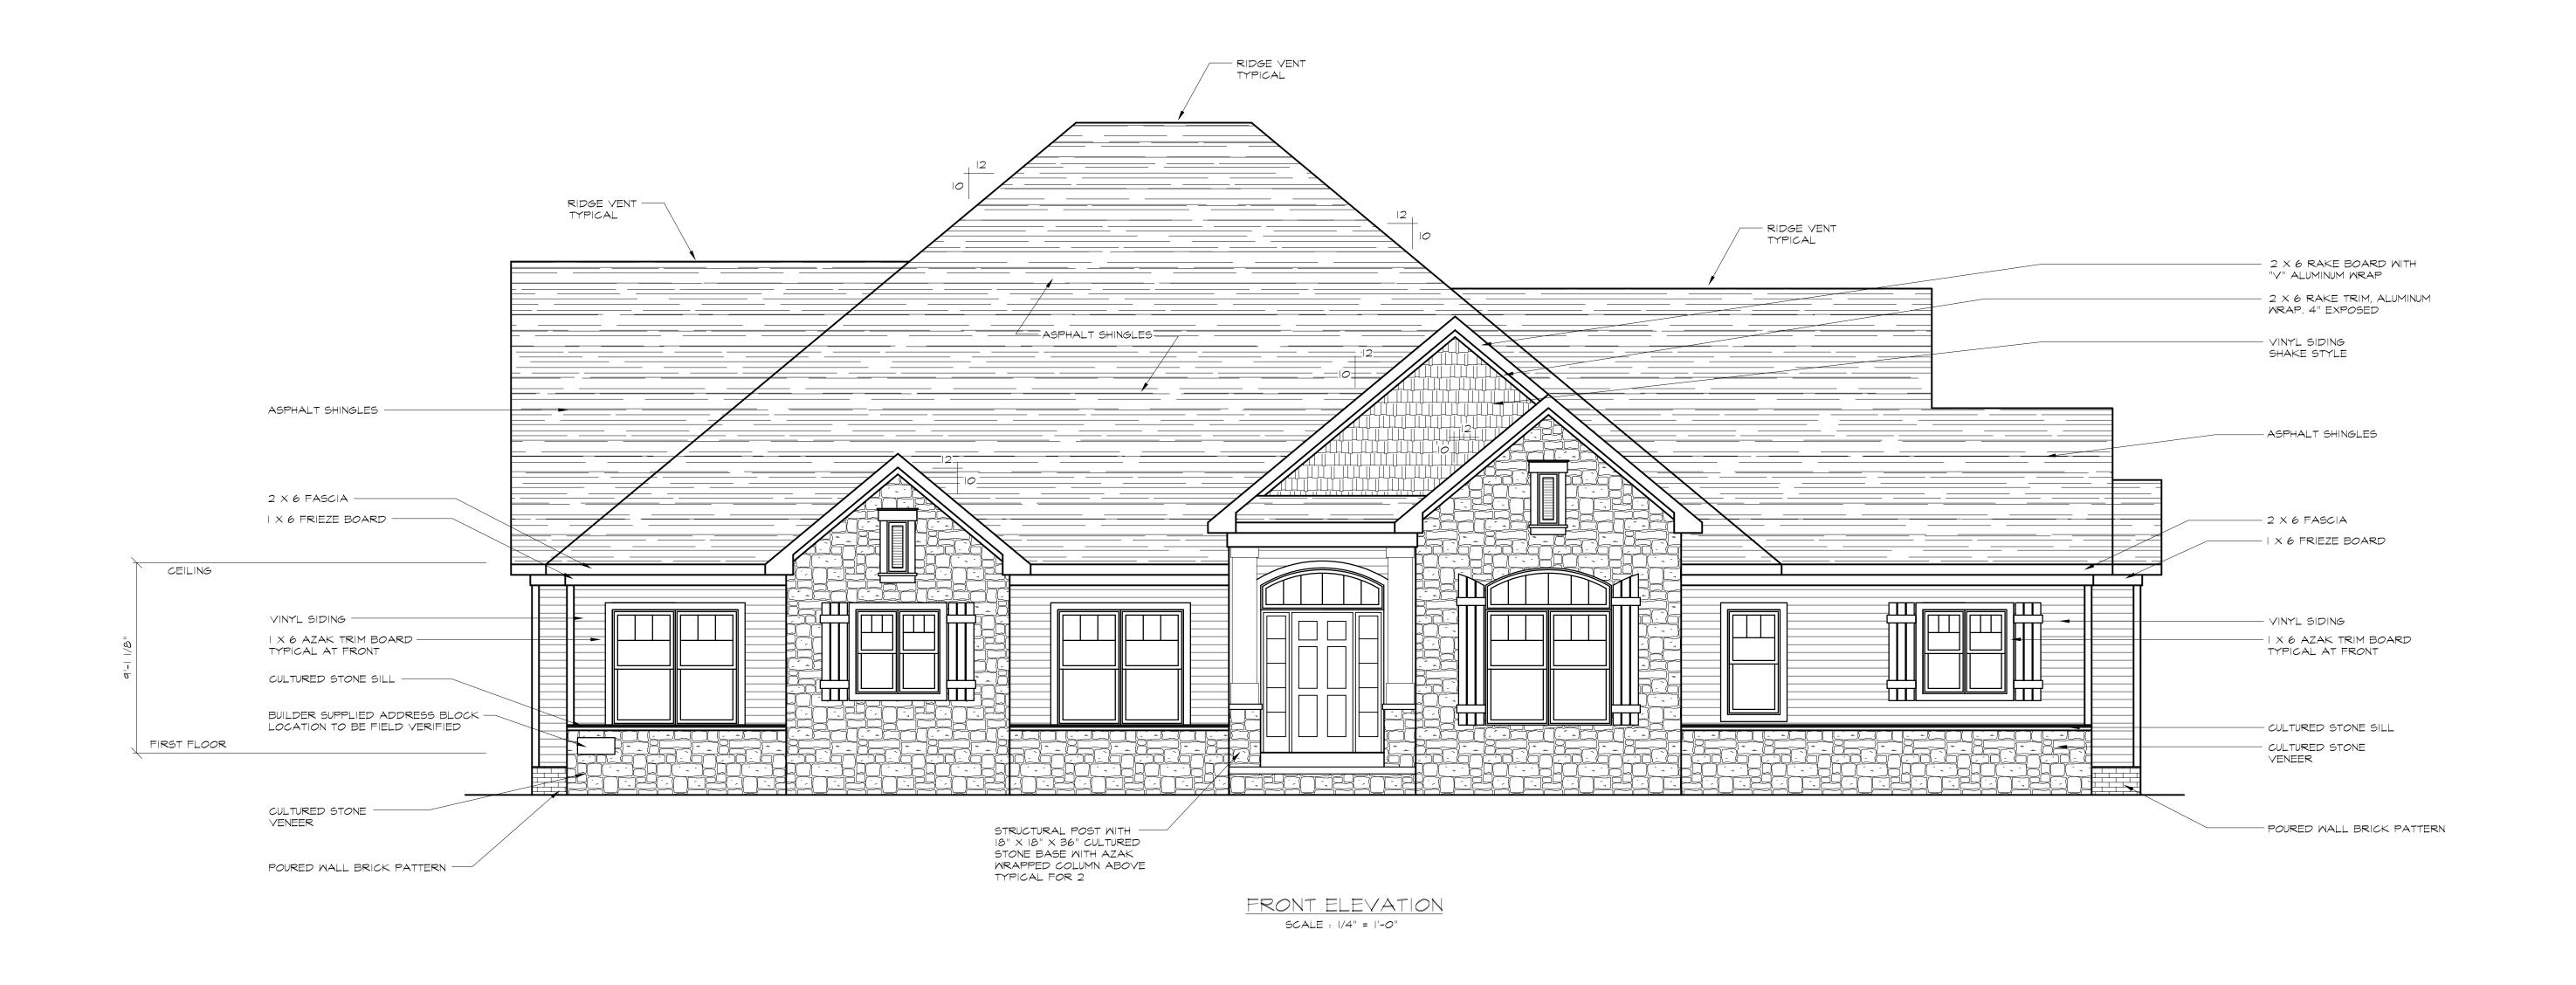



RIGHT ELEVATION SCALE: 1/4" = 1'-0"

LIST OF DRAWINGS

I. ELEVATIONS 2. ELEVATIONS

3. FOUNDATION PLAN

4. FIRST FLOOR PLAN
5. FINISHED BASEMENT

6. MISCELLANEOUS 7. DETAILS

SQUARE FOOTAGE TOTALS

FIRST FLOOR = 2843 SQ. FT.

GARAGE = 1011 SQ. FT.


PORCH = 55 SQ. FT.

COVERED PATIO = 295 SQ. FT.

BASEMENT SLAB = 2629 SQ. FT.

FINISHED BASEMENT = 746 SQ. FT.

DRAWING NUMBER

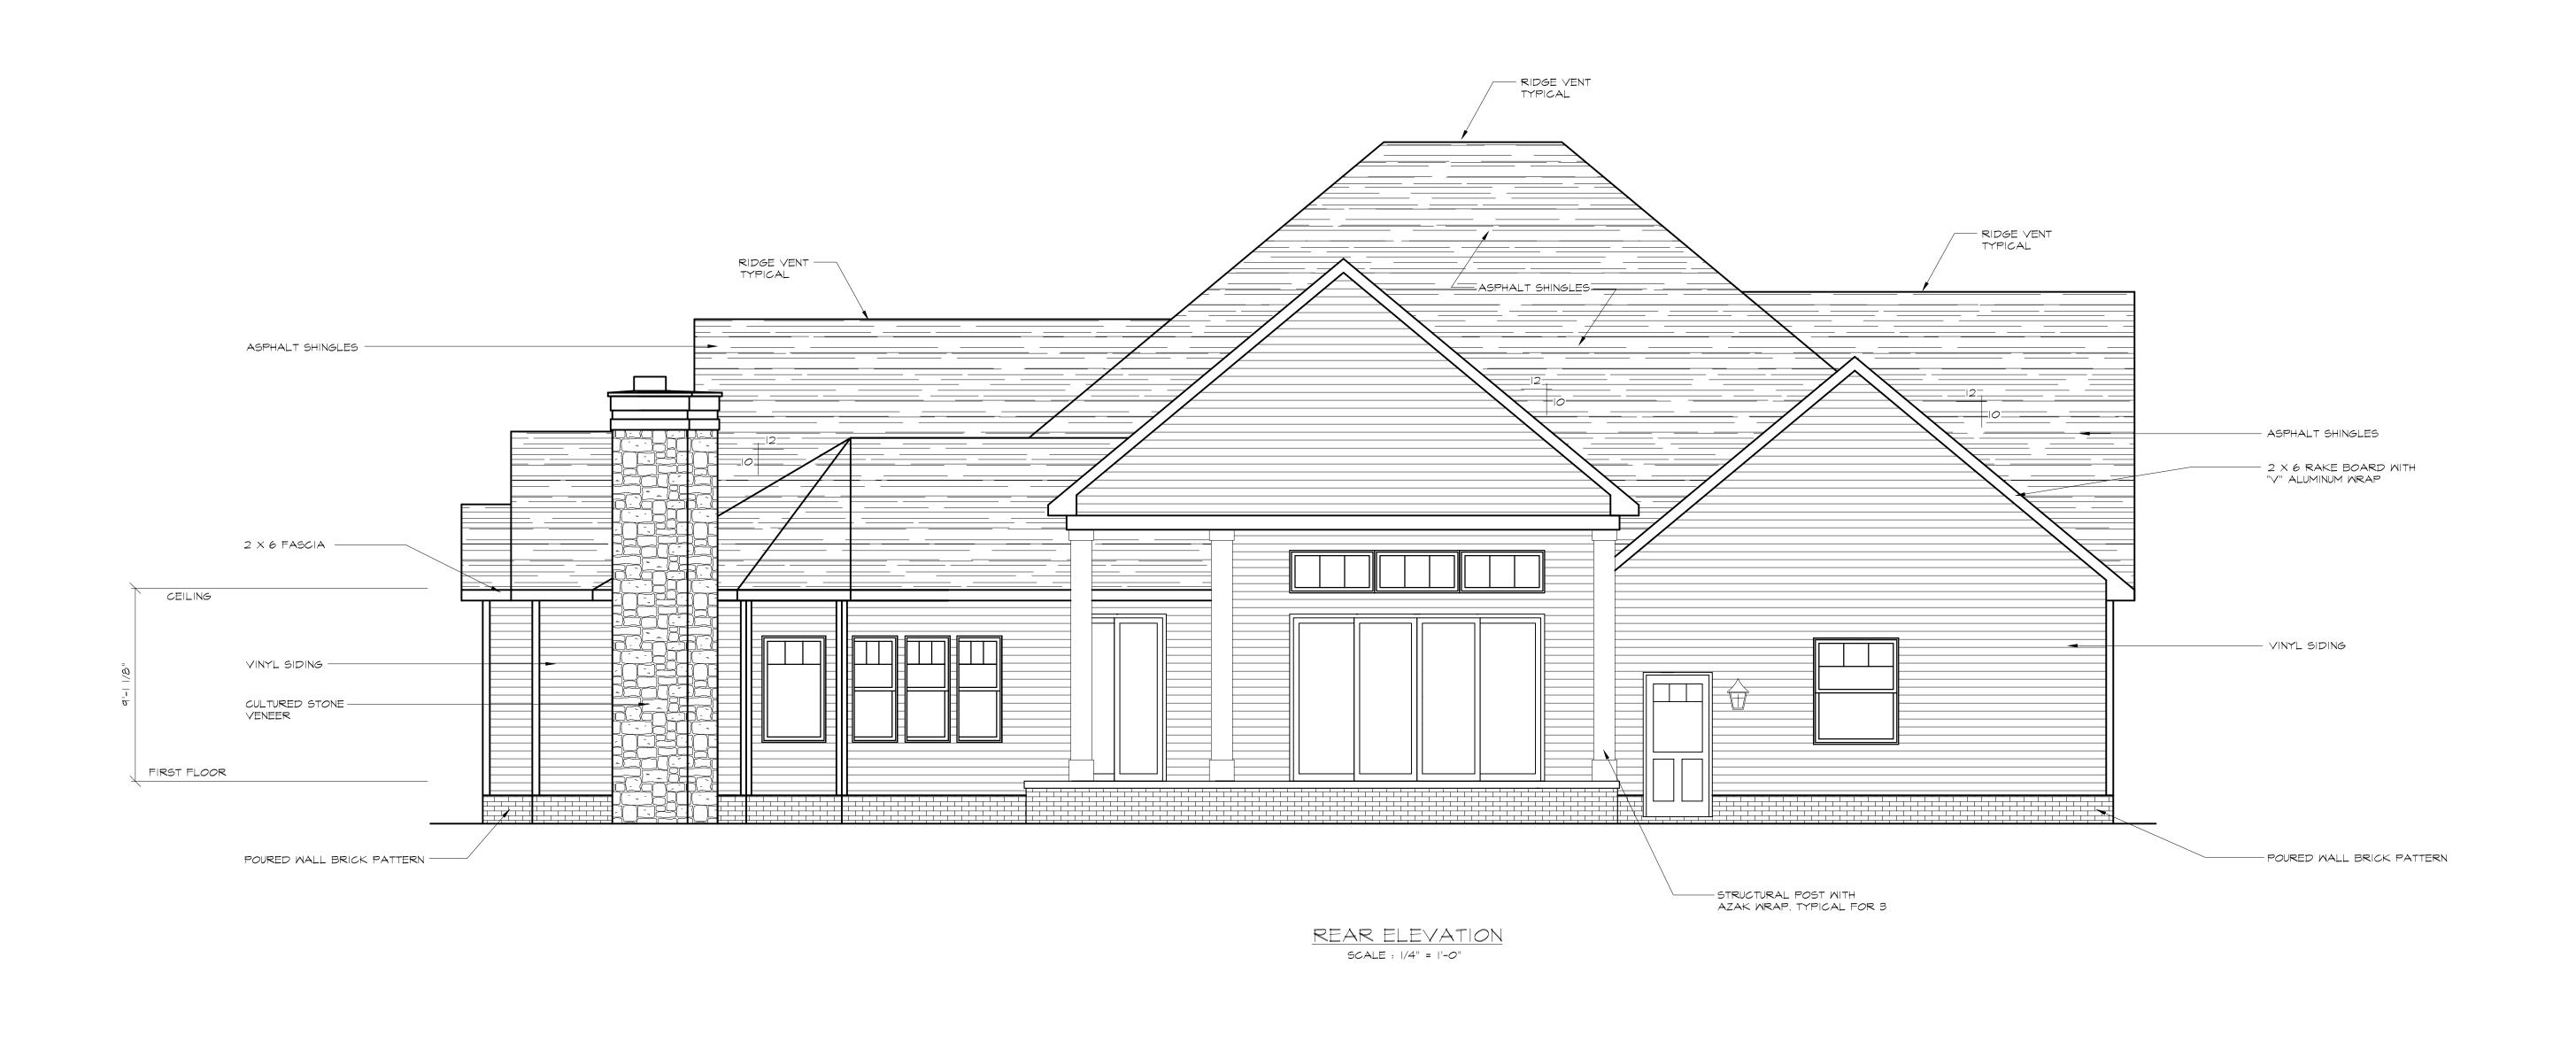




LEFT ELEVATION

SCALE: 1/4" = 1'-0"



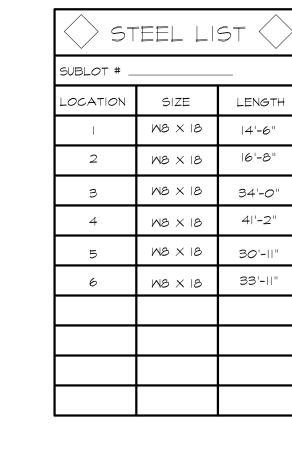

	WINDO	N SCHEDULE		
MANUFACT	urer <u>JELD WE</u>	Ν		
LOCATION	MANUFACTURER NUMBER	ROUGH OPENING SIZE	VENTING R L	MALL SIZE 4" 6"
ВІ	MPCC4848	4'-0" × 4'-0"		8"
B2	MPCC4848	4'-0" × 4'-0"		8"
B3	MPCC4848	4'-0" × 4'-0"		8"
B4	MPCC4848	4'-0" × 4'-0"		8"

TOP OF WINDOWS TO BE FLUSH WITH TOP OF POURED WALL

DRAWN BY DATE 3/9/18 SCALE


1/4" = 1'-0"

PROPERTY OF MODERN HOME CONCEPTS, ANY REPRODUCTION WITHOUT WRITTEN PERMISSION IS PROHIBITED


DENOTES WALL ABOVE

DOUBLE ALL FLOOR JOISTS BELOW ALL BATHS AND KITCHEN PER BUILDER

DRAWING NUMBER

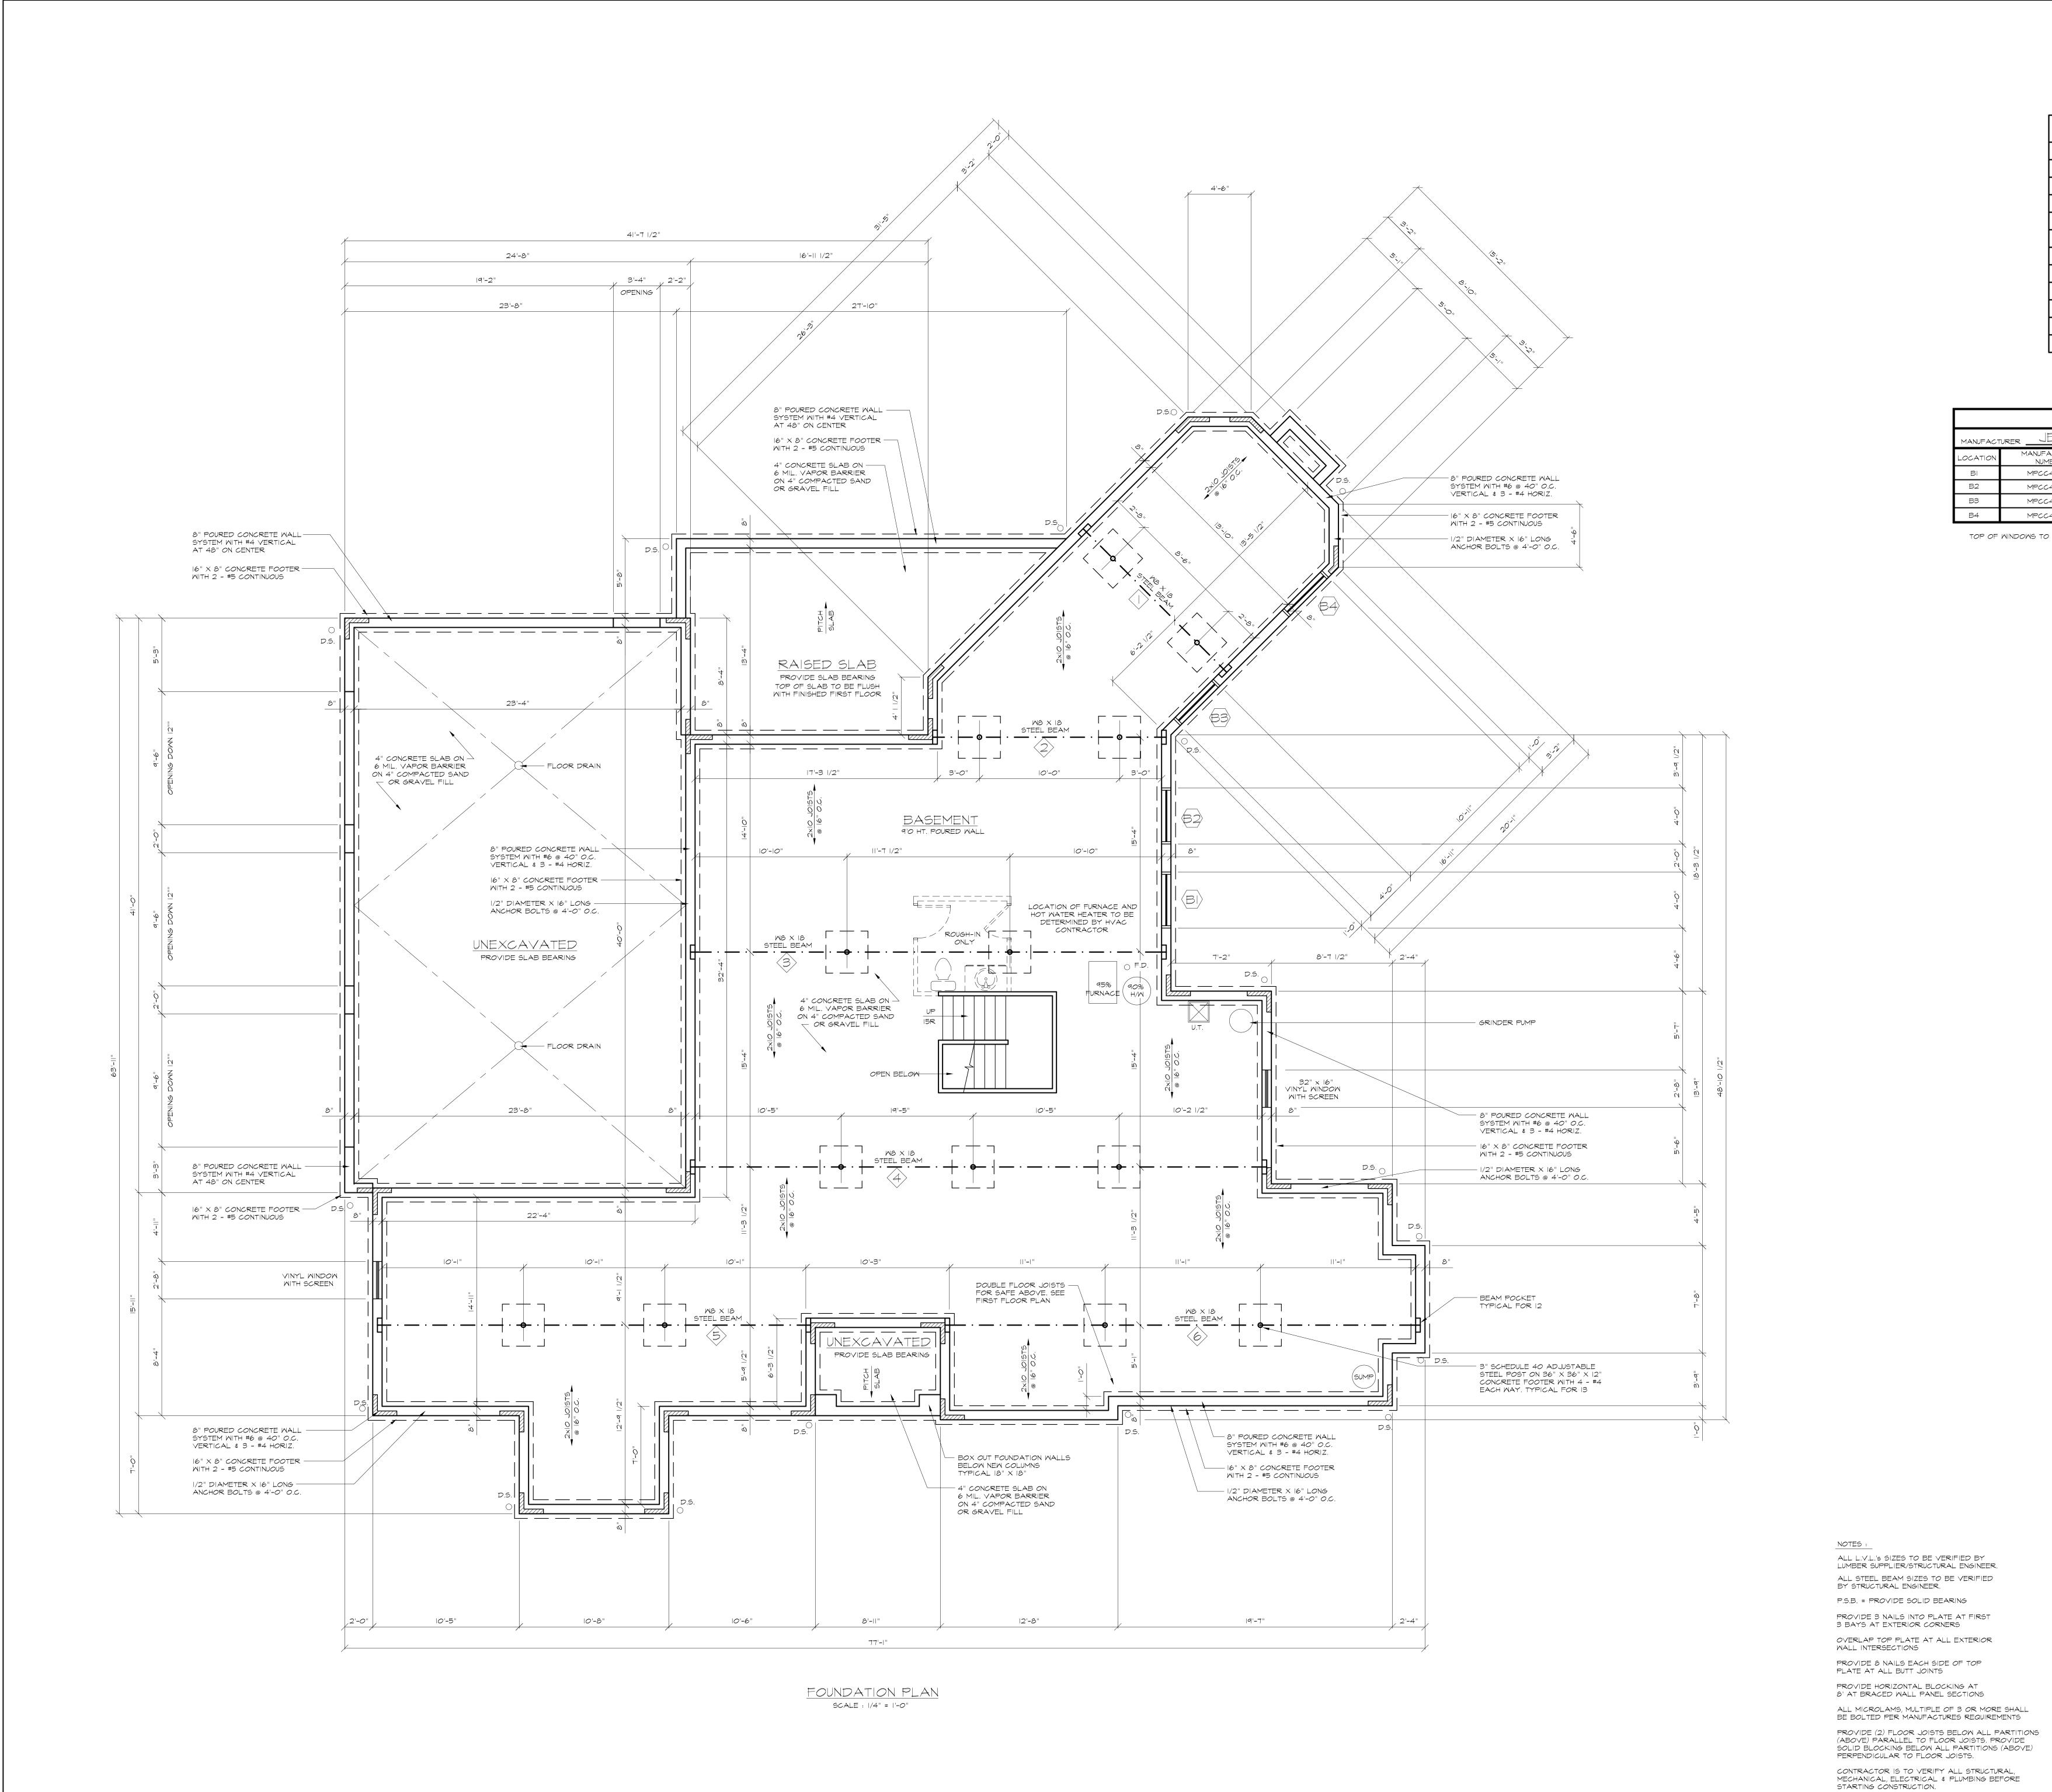



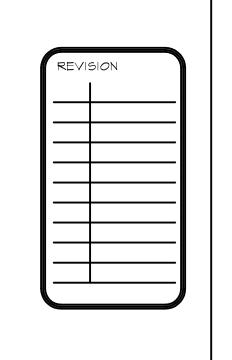

PROPOSED RESIDENCE
FRIES RESIDENCE
7523 HUNTINGTON ROAD
HUDSON, OHIO


NOOSTER, OHIO 44691 (330) 464-3369


MODERN HOME CONCEPTS



DRAWING NUMBER

PROPERTY OF MODERN HOME CONCEPTS. ANY REPRODUCTION WITHOUT WRITTEN PERMISSION IS PROHIBITED

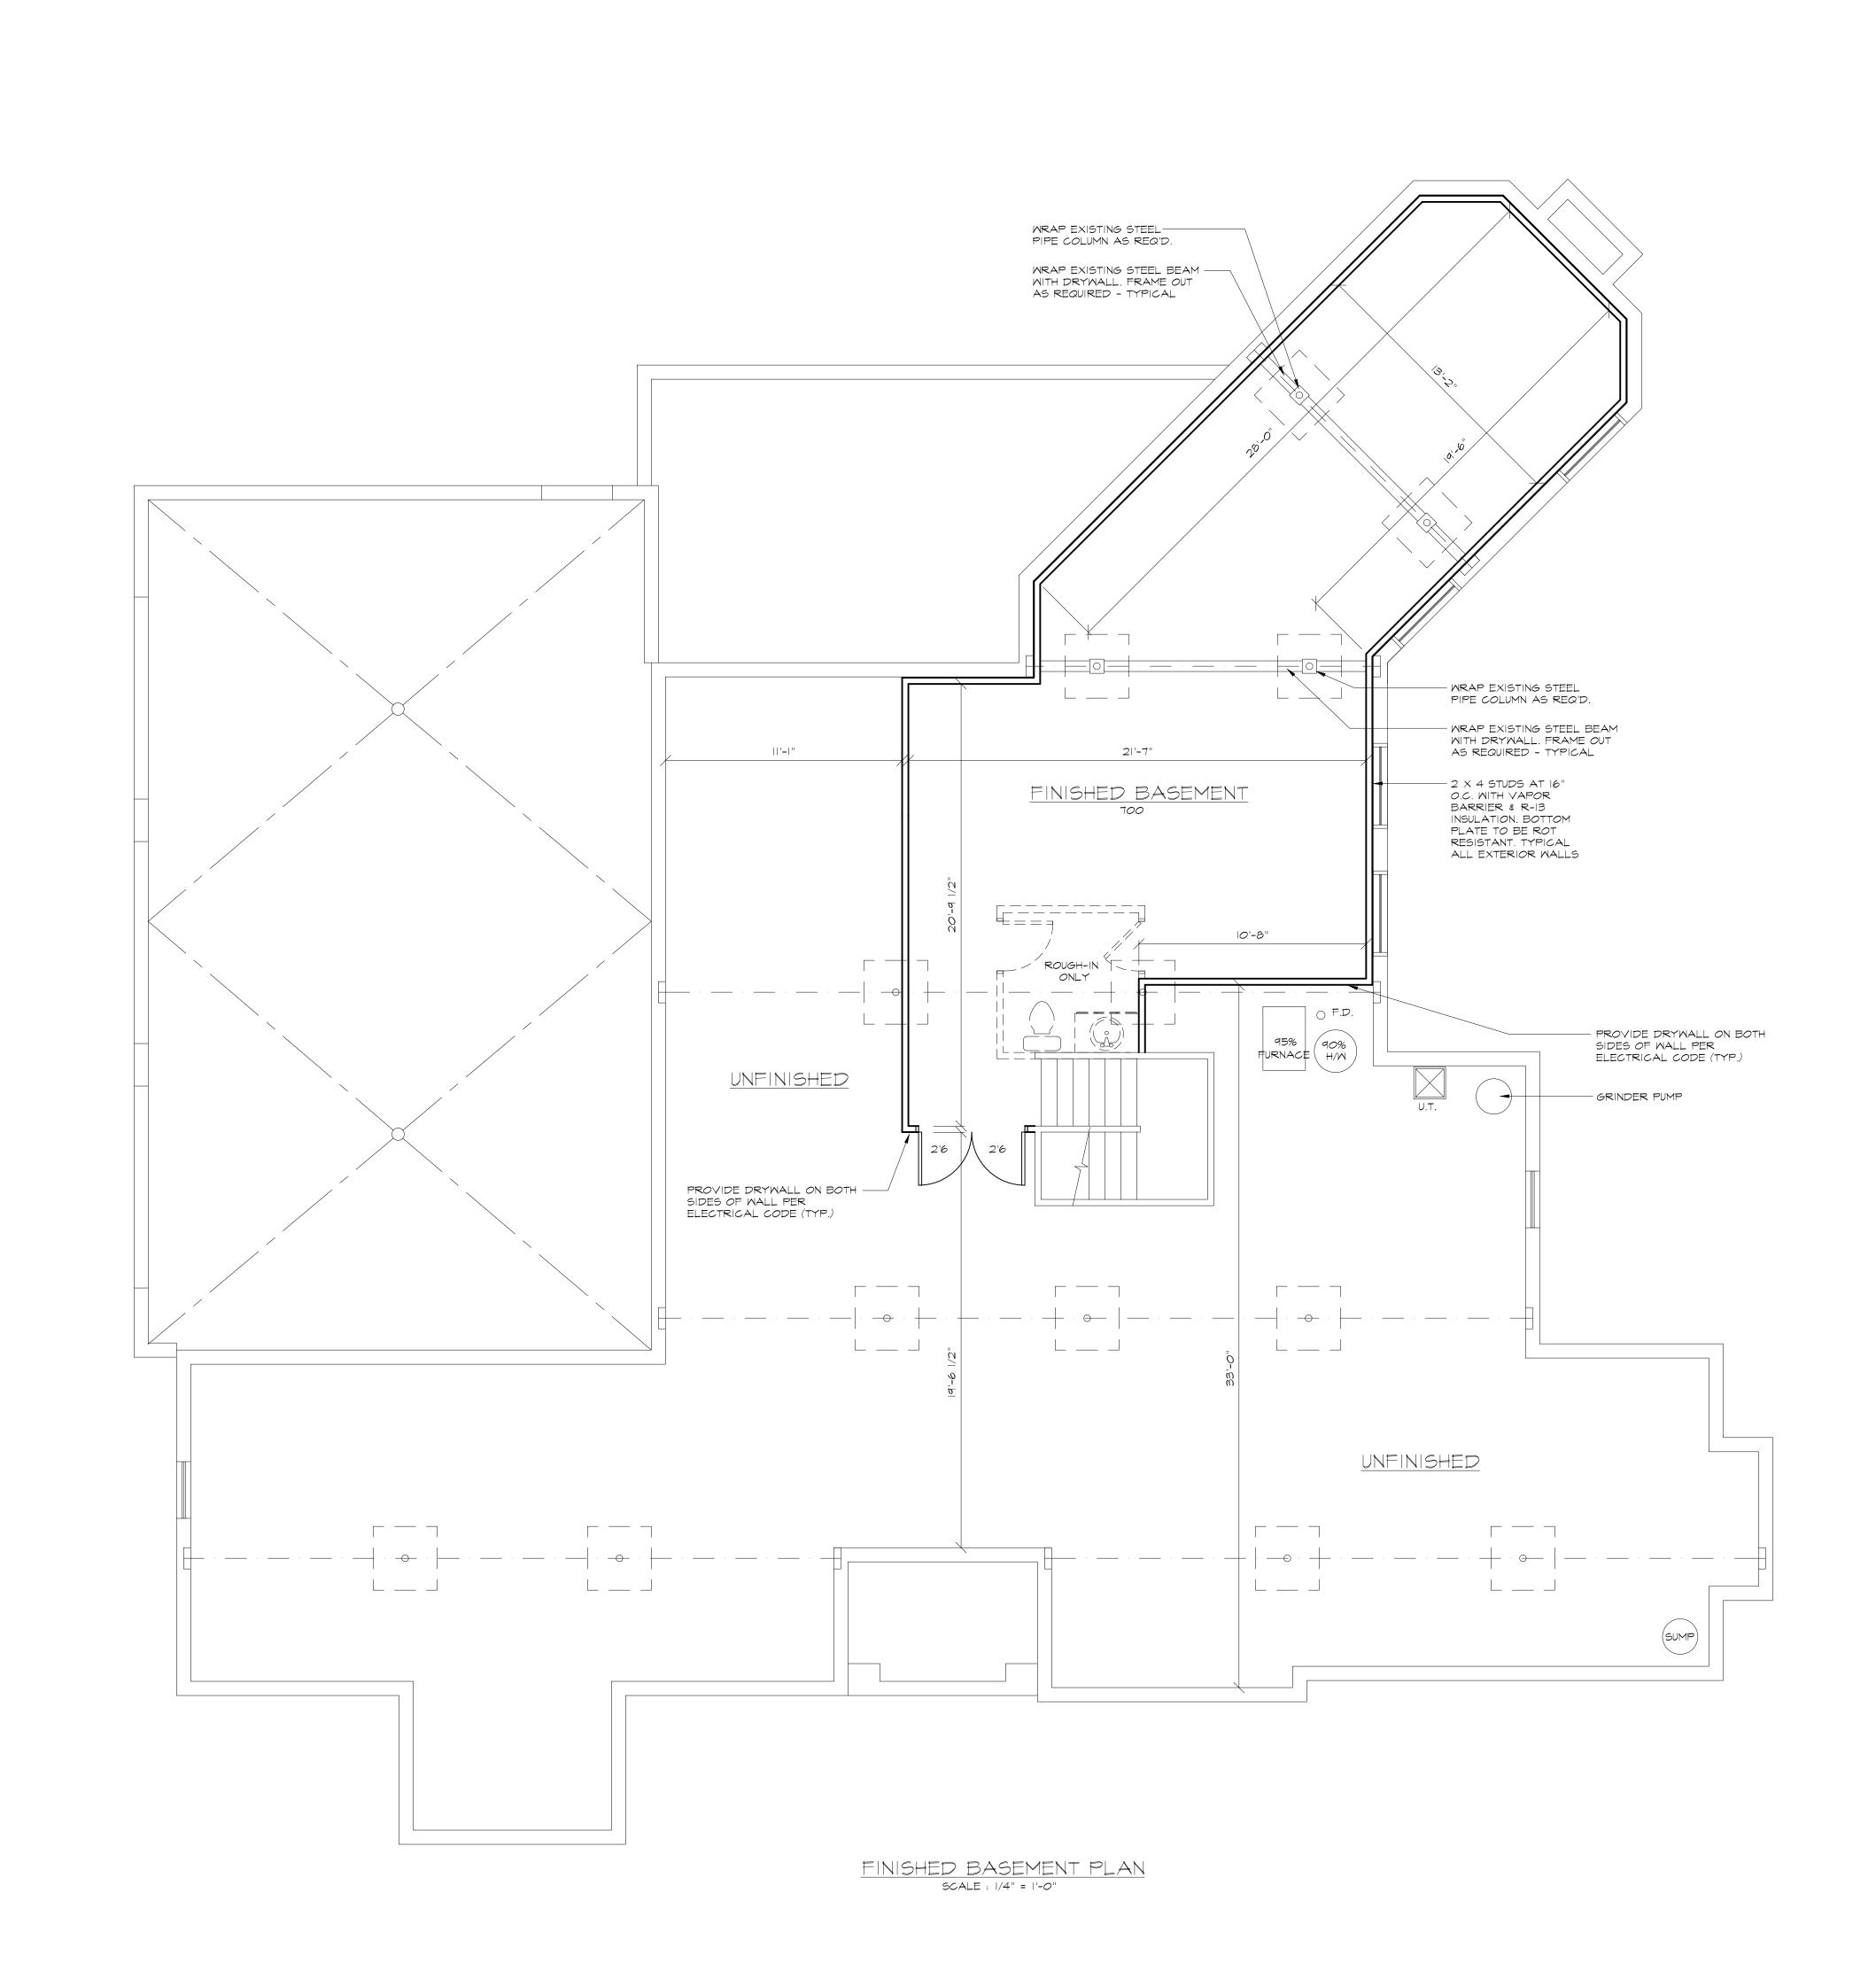

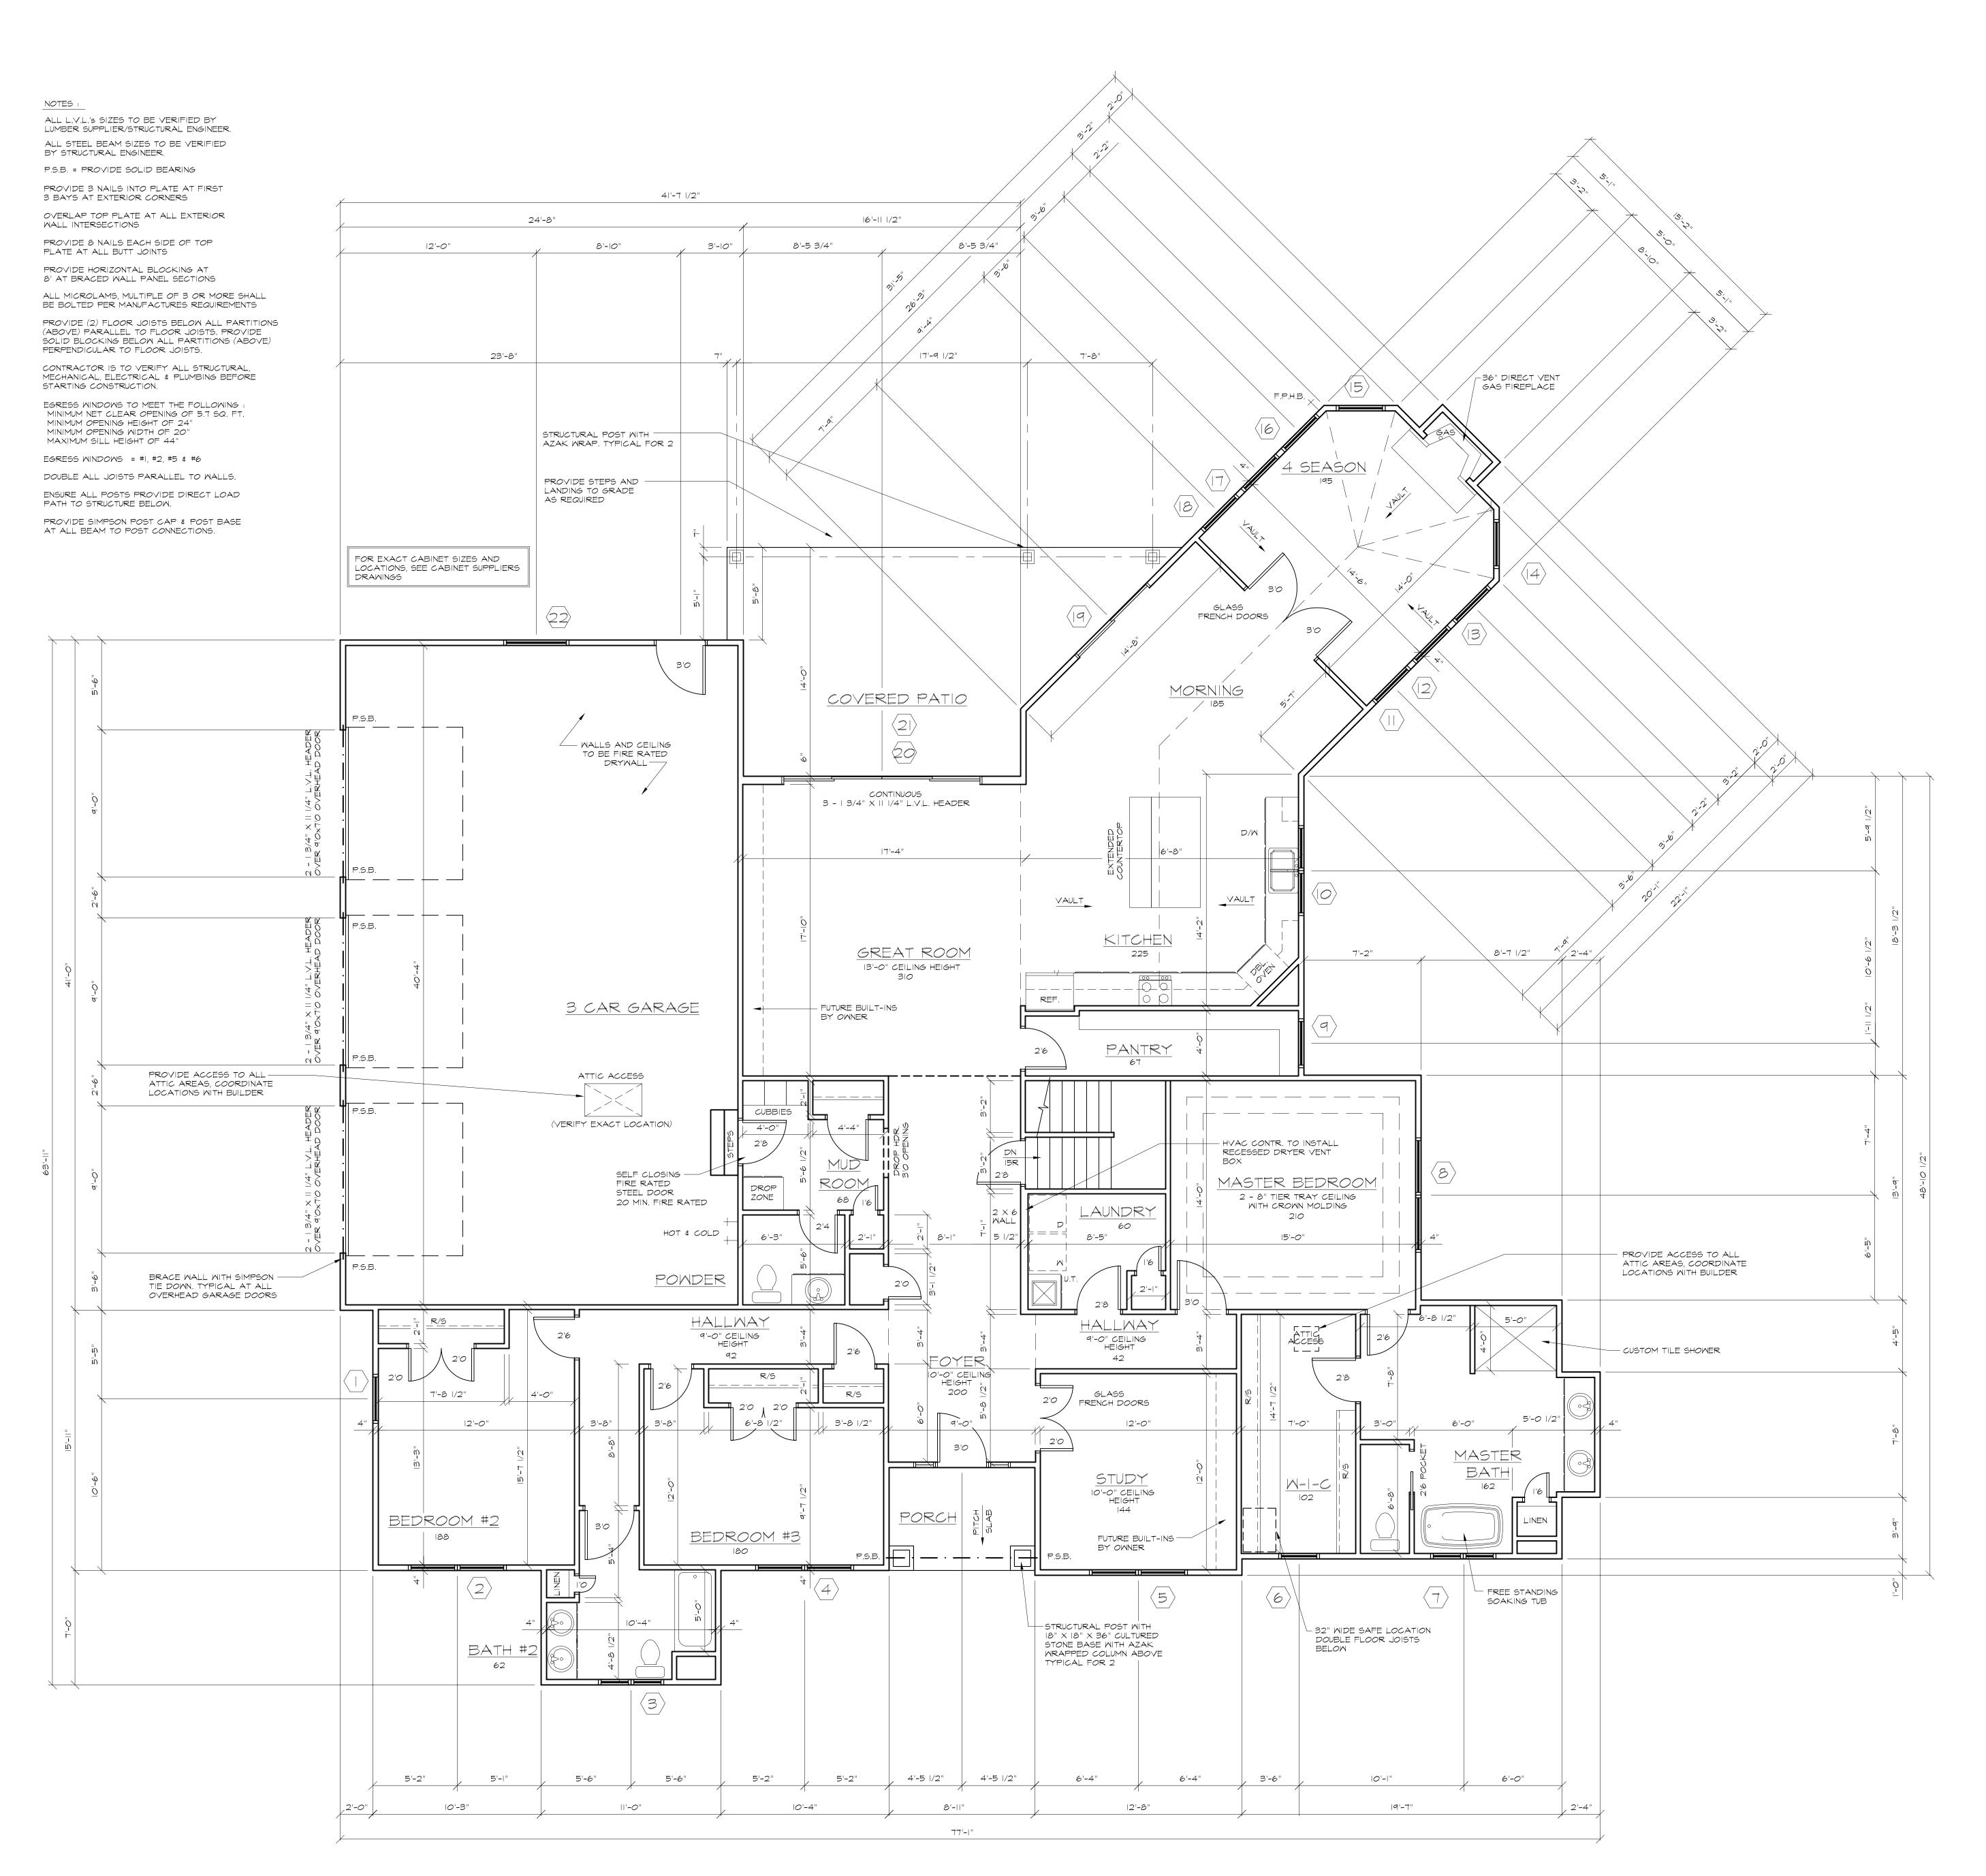



	MINDO	N SCHEDULE		
MANUFACT	urer JELD WEN	- SINGLE HUN	G	
LOCATION	MANUFACTURER NUMBER	ROUGH OPENING SIZE	VENTING R L	MALL SI 4" 6
	7SH3666	3'-0" × 5'-6"		4"
2	7SH7266-2	6'-0" × 5'-6"		4"
3	7SH4848-2	4'-0" × 4'-0"		4"
4	7SH7266-2	6'-0" × 5'-6"		4"
5	CUSTOM ARCH TRANS	6'-0" × 7'-6"		4"
6	7SH3060	2'-6" × 5'-0"		4"
7	7SH4848-2	4'-0" × 4'-0"		4"
8	75H8466-2	7'-0" × 5'-6"		4"
9	MPCC36123	3'-0" × 1'-0"		4"
10	8FCC6054-2	5'-0" × 4'-6"	L & R	4"
П	7SH3660	3'-0" × 5'-0"		4"
12	7SH3660	3'-0" × 5'-0"		4"
13	7SH3660	3'-0" × 5'-0"		4"
14	MPCC3660	3'-0" × 5'-0"		4"
15	MPCC3660	3'-0" × 5'-0"		4"
16	7SH3660	3'-0" × 5'-0"		4"
17	7SH3660	3'-0" × 5'-0"		4"
18	7SH3660	3'-0" × 5'-0"		4"
19	7296 SLIDER	6'-0" × 8'-0"		4"
20	14496 SLIDER	12'-0" × 8'-0"		6"
21	3 - MPCC4824	2'-0" × 2'-0"		4"
22	75H4860	4'-0" × 5'-0"		4"

MINDOM #5 TO HAVE 8'-10" HEADER HEIGHT & 5'-10" RADIUS MINDOM #10 TO HAVE 8'-0" HEADER HEIGHT MINDOM #21 TO HAVE 11'-0" HEADER HEIGHT

TEMPERED GLASS REQUIRED BY R.C.O. R 308.4 "HAZARDOUS LOCATIONS"

- THE FOLLOWING SHALL BE CONSIDERED SPECIFIC HAZARDOUS LOCATIONS REQUIRING SAFETY GLAZING MATERIALS :
- I. GLAZING IN SMINGING DOORS EXCEPT JALOUSIES.
- GLAZING IN FIXED OR SLIDING PANELS OF SLIDING DOOR ASSEMBLIES AND PANELS IN SLIDING AND BI-FOLD CLOSET DOOR ASSEMBLIES.
- 3. GLAZING IN EXTERIOR STORM DOORS.
- 4. GLAZING IN SECTION R 308.4 ITEM 6 IN WALLS PERPENDICULAR TO THE PLANE OF THE DOOR IN A CLOSED POSITION OR WHERE ACCESS THROUGH THE DOOR IS TO A CLOSET, STORAGE AREA OR BATHROOM. GLAZING IN THESE APPLICATIONS SHALL COMPLY WITH SECTION R 308.4 ITEM 7.
- 5. GLAZING IN DOORS AND ENCLOSURES FOR HOT TUBS, WHIRLPOOLS, SAUNAS, STEAM ROOMS, BATHTUBS AND SHOWERS. GLAZING IN ANY PORTION OF A BUILDING WALL ENCLOSING THESE COMPARTMENTS WHERE THE BOTTOM EDGE OF AN EXPOSED PANEL IS LESS THAN 60" ABOVE THE DRAIN INLET AND 36" HORIZONTALLY FROM THE INSIDE EDGE OF THE TUB OR COMPARTMENT.
- 6. GLAZING IN AN INDIVIDUAL FIXED OR OPERABLE PANEL ADJACENT TO DOOR WHERE THE NEAREST EXPOSED EDGE OF THE GLAZING IS WITHIN A 24" ARC OF EITHER VERTICAL EDGE. OF THE DOOR IN A CLOSED POSITION AND WHERE THE BOTTOM
- EXPOSED EDGE OF THE GLAZING IS LESS THAN 60" ABOVE THE WALKING SURFACE.

 7. GLAZING IN AN INDIVIDUAL FIXED OR OPERABLE PANEL OTHER THAN THOSE LOCATIONS DESCRIBED IN PRECEDING ITEMS NO. 5 AND NO. 6 WHICH MEETS ALL OF THE FOLLOWING CONDITIONS.

 7.I EXPOSED AREA OF AN INDIVIDUAL PANE GREATER THAN 9 SQUARE FEET.
- 7.2 EXPOSED AREA OF AN INDIVIDUAL PARL GREATER THAN 9 SQUARE FEET.

 7.2 EXPOSED BOTTOM EDGE LESS THAN 18" ABOVE THE FLOOR.

 7.3 EXPOSED TOP EDGE GREATER THAN 36" ABOVE THE FLOOR; AND

 7.4 ONE OR MORE WALKING SURFACES WITHIN 36" HORIZONTALLY OF THE PLANE OF
- 8. GLAZING IN RAILINGS REGARDLESS OF AREA OR HEIGHT ABOVE A WALKING SURFACE. INCLUDING STRUCTURAL BALUSTER PANELS AND NON STRUCTURAL IN-FILL PANELS.
- 9. GLAZING IN WALLS AND FENCES ENCLOSING INDOOR AND OUTDOOR SWIMMING POOLS, HOT TUBS AND SPAS WHERE THE BOTTOM EDGE OF THE GLAZING IN THE POOL OT SPA SIDE IS LESS THAN 60" ABOVE A WALKING SURFACE AND WITHIN 60" HORIZONTALLY OF THE WATERS EDGE OF A SWIMMING POOL OR SPA. THIS SHALL APPLY TO SINGLE GLAZING AND ALL PANELS IN MULTIPLE GLAZING.
- IO. GLAZING ADJACENT TO STAIRWAYS, LANDINGS AND RAMPS WITHIN 36" HORIZONTALLY OF A WALKING SURFACE WHEN THE EXPOSED SURFACE OF THE GLASS IS LESS THAN 60" ABOVE THE PLANE OF THE ADJACENT WALKING SURFACE.
- II. GLAZING ADJACENT TO STAIRWAYS WITHIN 60" HORIZONTALLY OF THE BOTTOM TREAD OF A STAIRWAY IN ANY DIRECTION WHEN THE EXPOSED SURFACE OF THE GLASS IS LESS THAN 60" ABOVE THE NOSE OF THE TREAD.

PORCHES, BALCONIES OR RAISED FLOOR SURFACES LOCATED MORE THAN 30" ABOVE THE FLOOR OR GRADE BELOW SHALL HAVE GUARDS NOT LESS THAN 36" IN HEIGHT. OPEN SIDES OF STAIRS WITH A TOTAL RISE OF MORE THAN 30" ABOVE THE FLOOR OR GRADE BELOW SHALL HAVE GUARDS NOT LESS THAN 34" IN HEIGHT MEASURED VERTICALLY FROM THE NOSING OF THE TREADS. REQUIRED GUARDS ON OPEN SIDES OF STAIRWAYS, RAISED FLOOR AREA, BALCONIES AND PORCHES SHALL HAVE INTERMEDIATE RAILS OR ORNAMENTAL CLOSURES WHICH DO NOT ALLOW PASSAGE OF A SPHERE 4" OR MORE IN DIAMETER.


NOTE: ALL STAIRS SHALL COMPLY WITH SECTION R 311.5 OF THE R.C.O. ALL CONSTRUCTION SHALL INCLUDE, BUT NOT BE LIMITED TO THE FOLLOWING:

1. ALL EXTERIOR DOORS SHALL HAVE A LANDING ON EACH SIDE OF THE DOOR. SEE EXCEPTIONS OR SECTION R 311.4.3 WHEN THESE LANDING MAY BE OMITTED.

2. GUARDS SHALL BE INSTALLED AS REQUIRED BY SECTION R 312.1 OF THE R.C.O.

3. HANDRAILS SHALL BE INSTALLED ON AT LEAST ONE SIDE OF CONTINUOUS RUN OF TREADS OR FLIGHT WITH FOUR OR MORE RISERS. THE HANDRAIL SHALL BE LOCATED NOT LESS THAN 34" AND NOT MORE THAN 38" FROM THE SLOPED PLANE OF THE TREAD NOSING.



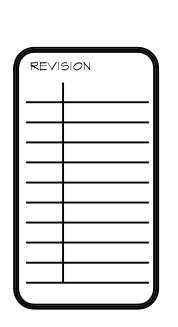

PROPOSED RESIDENCE
FRIES RESIDENCE
1523 HUNTINGTON ROAD
HUDSON, OHIO

||77 СНURCH HILL COURT | MOOSTER, ОНІО 4469| (330) 464-3369

MODERN HOME

DRAWN BY
J.R.G.

DATE
3/9/18

SCALE
1/4" = 1'-0"

DRAMING NUMBER

PROPERTY OF MODERN HOME CONCEPTS. ANY REPRODUCTION WITHOUT WRITTEN PERMISSION IS PROHIBITED

GENERAL NOTES

WHEN THIS PLAN IS SUBMITTED FOR PERMIT IT IS UNDERSTOOD THAT THE BUILDER HAS REVIEWED THE DOCUMENTS AND HAS ACCEPTED THE PLANS AS READY TO CONSTRUCT. IF QUESTIONS ARISE CONTACT THE DESIGNER IMMEDIATELY.

ALL SPECIFICATIONS FOR THIS PROJECT SHALL CONFORM TO INTERNATIONAL CODE (LATEST EDITION) WHETHER INDICATED OR NOT. THE USE OF THESE DOCUMENT IS RESTRICTED TO THE ORIGINAL SITE FOR WHICH THEY WERE PREPARED. REUSE OR REPRODUCTION OF THE DOCUMENTS (IN WHOLE OR IN PART) FOR ANY OTHER PURPOSE IS PROHIBITED.

IF A DISCREPANCY OR CONFLICT BETWEEN CODE REQUIREMENTS, DRAWING DETAILS, SPECIFICATIONS, ENGINEERING DATA, MANUFACTURERS RECOMMENDATIONS OR OWNER PROVIDED INFORMATION BECOMES KNOWN TO THE CONTRACTOR, HE OR SHE SHALL PROMPTLY REPORT THE CONFLICT OR DISCREPANCY TO THE OWNERS REPRESENTATIVE FOR CLARIFICATION AND CORRECTIVE ACTION. IN ADDITION ANY WORK INSTALLED IN CONFLICT WITH REQUIREMENTS IDENTIFIED HEREIN WITHOUT PROPER NOTIFICATION SHALL BE CORRECTED BY THE CONTRACTOR AT HIS OR HER EXPENSE AND NO COST TO THE ARCHITECT, DESIGNER, ENGINEER, OCCUPANT OR BUILDING OWNER

SUB-CONTRACTOR SHALL DETERMINE ERECTION PROCEDURE AND SEQUENCING AND PROVIDE WHATEVER BRACING THAT MAY BE REQUIRED TO COMPLETE THE WORK.

VERIFY ALL ROUGH OPENINGS WITH THE MANUFACTURER PRIOR TO FRAMING.

EACH SUB-CONTRACTOR SHALL OBTAIN AND PAY FOR REQUIRED PERMITS AND SCHEDULE ALL INSPECTIONS AND COORDINATE ALL TRADES.

THE CONTRACTOR AND SUB-CONTRACTORS SHALL BE SOLELY RESPONSIBLE FOR COMPLYING WITH ALL FEDERAL, STATE AND LOCAL SAFETY REQUIREMENTS TOGETHER WITH EXERCISING PRECAUTIONS AT ALL TIMES FOR THE PROTECTION OF ALL

IT IS THE SOLE RESPONSIBILITY OF THE CONTRACTOR AND SUB-CONRTACTORS TO INITATE, MAINTAIN AND SUPERVISE ALL SAFETY REQUIREMENTS, PRECAUTIONS AND PROGRAMS IN CONNECTION WITH THE WORK.

REQUIREMENTS, PRECAUTIONS AND PROGRAMS IN CONNECTION WITH THE WORK.

ALL SYMBOLS AND ABBREVIATIONS USED ON THESE DRAWINGS ARE CONSIDERED TO BE CONSTRUCTION STANDARDS. IF THE

CONTRACTOR HAS QUESTIONS REGARDING THE ABBREVIATIONS OR SYMBOLS AS TO THEIR EXACT MEANING THE DESIGNER SHALL BE NOTIFIED FOR CLARIFICATION

ALL EXTERIOR WALLS ARE SHOWN AT 4" UNLESS NOTED OTHERWISE. ALL INTERIOR WALLS ARE SHOWN AT 3 1/2" UNLESS

WRITTEN DIMENSIONS TAKE PRECEDENCE OVER SCALED DIMENSIONS.

PERSONS INCLUDING EMPLOYEES AND PROPERTY.

NOTIFY CONTRACTOR OF ANY DISCREPANCIES. CONTRACTOR TO VERIFY ALL MEASUREMENTS ON SITE.

ALL WINDOWS ARE INDICATED BY FRAME SIZE. ALL WINDOWS SHALL HAVE DESIGN PRESSURE RATING IN ACCORDANCE WITH R.C.O. 612.5

PROVIDE | 3/4" INSULATED METAL DOOR (C LABEL) OR EQUAL TO GARAGE.

SMOKE DETECTORS SHALL BE HARD WIRED AND INTERCONNECTED WITH BATTERY BACK UP.

PROVIDE CARBON MONOXIDE DETECTORS OUTSIDE EACH SLEEPING ROOM.

ALL UNDERGROUND ELECTRICAL LINES SHALL BE EMBEDDED IN SAND.

SUMP PUMPS (IF REQUIRED) SHALL HAVE AN IN LINE CHECK VALVE.

ALL HABITABLE ROOMS SHALL HAVE AGGREGATE GLAZING OF NOT LESS THAN 8% OF THE FLOOR AREA OF THE ROOM.

ROOMS USED FOR SLEEPING SHALL COMPLY WITH R.C.O. SECTION 310.1 FOR EGRESS REQUIREMENTS.

ENCLOSED ACCESSIBLE SPACE UNDER STAIRS SHALL HAVE WALLS AND SOFFITS PROTECTED ON ALL SIDES WITH 5/8"

GYPSUM BOARD.

ALL HANDRAILS SHALL BE MOUNTED BETWEEN 34" MIN. \$ 38" MAX., MEASURED FROM THE NOSING OF THE TREAD.

PORCH AND BALCONY RAILINGS SHALL FORM A GUARD NOT LESS THAN 36" IN HEIGHT WHEN MORE THAN 30" ABOVE FLOOR

OR GRADE BELOW.

ALL BALUSTERS SHALL BE SPACED TO PROHIBIT A SPHERE 4" IN DIAMETER FROM PASSAGE THROUGH IT.

STEP FLASH ALL ROOF AND WALL INTERSECTIONS WITH KICK FLASHING AT GUTTER WALL LOCATIONS.

MINIMUM HEADROOM AT ALL STAIRS SHALL BE 6'-8"

PROVIDE HANDRAILS AT ALL STAIRS PER CODE.

ALL MECHANICAL FLUES SHALL BE ROUTED TO THE REAR OF THE HOUSE.

CONDENSING UNITS SHALL BE PLACED IN THE REAR OR SIDE YARDS, DEPENDING ON ZONING. CONSULT WITH OWNER AND BUILDING OFFICIAL ON THE FINAL LOCATION.

ASSUMED SOIL BEARING CAPACITY ID 2,000 P.S.F. THE CONTRACTOR IS RESPONSIBLE FOR VERIFYING THIS CAPACITY. A GEOTECHNICAL ENGINEER SHALL BE THE RESPONSIBILITY OF THE CONTRACTOR AND/OR HOME OWNER.

ALL GARAGE DOORS OPERATED BY AN ELECTRIC OPENER SHALL HAVE AN AUTOMATIC SAFETY/REVERSE FEATURE.

ALL STAIRS SHALL COMPLY WITH R.C.O. 311.7.4.1 NO RISER SHALL EXCEED 8 1/4" AND NO TREAD SHALL BE LESS THAN 9".

ALL TOILET AND BATH/SHOWER AREAS SHALL HAVE AND EXHAUST FAN VENTED TO THE EXTERIOR.

PROVIDE SILL PITCH ON ALL WINDOWS AND DOORS TOWARD THE EXTERIOR.

PROVIDE PAN FLASHING FOR ALL OPENINGS.

PROVIDE ALL NECESSARY, UNSPECIFIED FLASHING.

PROVIDE ALL NECESSARY, UNSPECIFIED ROOF SADDLES.

PROVIDE 36" OF CONTINUOUS "ICE GUARD" ROOF PROTECTION AT ALL EAVES.

PROVIDE ALL NECESSARY DOWN SPOUTS AND FOOTING DRAINS WITH CONNECTIONS TO LOCAL STORM SEWER.

VERIFY THE EXACT LOCATION OF THE WATER HEATER AND FURNACE PRIOR TO INSTALLATION OF FLOOR DRAINS.

VERIFY ALL COLOR SELECTIONS, FINISH SELECTIONS ETC. WITH THE OWNER.

IT IS THE RESPONSIBILITY OF THE BUILDER TO NOTIFY THE OWNER TO KNOW THAT ALL HOUSES HAVE THE POTENTIAL TO HAVE RADON LEVELS WHICH MAY EXCEED THE RECOMMENDED LEVELS ESTABLISHED BY THE UNITED STATES ENVIRONMENTAL PROTECTION AGENCY. THE BUILDER AND/OR OWNER SHALL DECIDE WHAT ACTION, IF ANY,

FOR ANY ELEMENTS OF CONSTRUCTION NOT SPECIFICALLY NOTED ON THESE PLANS, COMPLY WITH THE LATEST EDITION OF THE RESIDENTIAL CODE OF OHIO.

ALL PLUMBING, ELECTRICAL, HEATING AND COOLING SYSTEMS SHALL COMPLY WITH ALL ORDINANCES SET FORTH BY THE LOCAL GOVERNING BUILDING AND ZONING DEPARTMENTS. PLUMBING SHALL ALSO COMPLY WITH THE OHIO PLUMBING CODE. ELECTRICAL SHALL ALSO COMPLY WITH THE NATIONAL ELECTRIC CODE AND THE OHIO

BASIC BUILDING CODE.

IT IS THE RESPONSIBILITY OF THE BUILDER AND/OR OWNER TO RETAIN THE SERVICES OF A REGISTERED SURVEYOR OR ENGINEER TO COMPLETE AN ACCURATE SITE AND GRADING PLAN.

IT IS THE RESPONSIBILITY OF THE BUILDER AND/OR OWNER TO HAVE ALL ACTUAL MECHANICAL SYSTEMS

DESIGNED AND INSTALLED BY LICENSED MECHANICAL SPECIALISTS.

ALL ENCLOSED ATTIC AND RAFTER SPACES SHALL HAVE CROSS VENTILATION WITH THE NET FREE VENTILATING AREA NOT LESS THAN 1/300 OF THE AREA TO BE VENTILATED. ALL OPENINGS SHALL BE PROTECTED AGAINST THE ENTRANCE OF SNOW AND RAIN.

MASONRY NOTES

ALL FOOTINGS TO BE 8" WIDER THAN THE WALL THEY SUPPORT AND BEAR ON UNDISTURBED SOIL OF BEARING CAPACITY.

THE TOP OF ALL FOOTINGS SHALL BE A MINIMUM OF 42" BELOW GRADE.

PROVIDE C.M.U. "LOOKOUTS" @ 4'-O" ON CENTER WHERE SHELVES ARE NOT PROVIDED.

PROVIDE 1/2" X 18" ANCHOR BOLTS OR TIE STRAPS @ 6'-0" ON CENTER AND ALL CORNERS.

PROVIDE SOLID MASONRY AT ALL BEAM BEARING LOCATIONS. SOLID MASONRY TO EXTEND DOWN TO FOOTING.

PROVIDE 1/2" CEMENT, TAR & IRONITE DAMPPROOFING ON ALL FOUNDATION WALLS.

PROVIDE GALVANIZED CORRUGATED METAL TIES @ 16" ON CENTER HORIZONTALLY & VERTICALLY FOR ALL MASONRY VENEERS.

PROVIDE &" SOLDIER \$ 4" ROWLOCK AT ALL WINDOW AND DOOR OPENINGS, PROJECTED 1/2" WHERE NOTED.

PROVIDE WEEP HOLES @ 33" ON CENTER ON FIRST COURSE EXPOSED ABOVE GRADE AS REQUIRED.

PROVIDE 30# FELT OVER ALL SHEATHING TO RECEIVE BRICK VENEER. LAP ALL JOINTS A MINIMUM OF 6".

FLASHING SHALL BE INSTALLED PER SECTION 703.8 OF THE OHIO RESIDENTIAL CODE.

PROVIDE EXTERIOR COMBUSTION AIR FOR ALL FIREPLACES. (MINIMUM 6 SQUARE INCHES).

FIREPLACE HEARTHS SHALL BE SIZED AS FOLLOWS:

FIREPLACE HEARTHS SHALL BE SIZED AS FOLLOWS:
FIREBOX OPENING LESS THAN 6 SQ. FT. = 16" WIDE FROM FACE OF FIREBOX
FIREBOX OPENING GREATER THAN 6 SQ. FT. = 20" FROM FACE OF FIREBOX

FOUNDATIONS SHALL NOT BE BACKFILLED UNLESS PROPERLY BRACED.

PROVIDE HORIZONTAL JOINT REINFORCING @ 16" ON CENTER VERTICALLY.

PROVIDE ONE (I) #6 BAR VERTICALLY (FULL HEIGHT) @ 32" ON CENTER IN GROUTED CORE. UNLESS NOTED OTHERWISE.

SLOPE ALL SILLS AWAY FROM THE STRUCTURE.

STEP DOWN ALL FOOTINGS AS NECESSARY WHERE ANY UNEXCAVATED SLAB AREAS MEET A LOWER BASEMENT TO PROVIDE

STEP DOWN ALL FOOTINGS AS NECESSARY AT ALL WALK-OUT BASEMENT AREAS TO CONTINUOUSLY MAINTAIN THE MINIMUM REQUIRED DEPTH BELOW FINISH GRADE.

RIRECTUTEOS PARAPED BY MASONRY CONTRACTOR...

FOUNDATIONS SHOWN ON THESE DRAWINGS ARE DESIGNED FOR AN ALLOWABLE SOIL BEARING PRESSURE OF 2,000 psi, WALLS ARE DESIGNED FOR AN EQUIVALENT FLUID PRESSURE OF 55 pcf. IT IS THE RESPONSIBILITY OF THE BUILDER AND/OR OWNER TO DETERMINE THAT THE SOIL IS ADEQUATE TO SUPPORT THIS BUILDING ON THE FOUNDATION AND THE WALLS SHOWN, AND ALSO DETERMING THAT THE TOTAL AND DIFFERENTIAL SETTLEMENTS OF THE FOUNDATION ARE WITHIN THE TOLERABLE LIMITS OF THIS STRUCTURE AND THAT 55 pcf IS THE CORRECT WALL LOADING. THE BUILDER AND/OR OWNER IS ENCOURAGED TO OBTAIN THE SERVICES OF A SOILS ENGINEERING FIRM TO DETERMINE THE SUITABILITY OF THE FOUNDATIONS AND THE WALLS SHOWN ON THESE DRAWINGS TO SAFELY SUPPORT THE STRUCTURE WITH NO DETRIMENTAL EFFECT TO THE BUILDING.

FRAMING NOTES

BUILDER AND/OR OWNER IS RESPONSIBLE TO VERIFY THAT ALL STRUCTURE MATCHES THE PLANS AS DRAWN AND DESIGNED.

ENGINEERED ROOF TRUSSES ARE THE RESPONSIBILITY OF THE BUILDER AND/OR OWNER., LUMBER COMPANY AND TRUSS MANUFACTURER. TRUSS DESIGNED ROOF PLANS ARE TO BE REVIEWED BY THE TRUSS MANUFACTURER PRIOR TO PRINTING FINAL CONSTRUCTION SETS. DURING THIS REVIEW PROCESS IT WILL BE THE RESPONSIBILITY OF THE TRUSS MANUFACTURER TO VERIFY THAT ALL THE PLATE HEIGHTS, HEEL HEIGHTS AND ROOF PITCHES WILL CREATE A BUILDABLE PACKAGE. THE TRUSS MANUFACTURER IS ALSO RESPONSIBLE TO VERIFY, AND IF NECESSARY ADJUST THE SIZE OF OR ADD ANY BEAM, POST OR HEADER THAT IS DIRECTLY EFFECTED OR REQUIRED TO CARRY THE ROOF LOADS.

IT IS THE RESPONSIBILITY OF THE BUILDER AND/OR OWNER TO FIELD VERIFY ALL AS BUILT DIMENSIONS OF FOUNDATION AND FRAMING PRIOR TO ORDERING TRUSSES.

ALL TRUSSES ARE TO BE DESIGNED BY THE TRUSS MANUFACTURER WITH DETAILED DRAWINGS DESCRIBING TRUSS LAYOUTS AND LOAD CALCULATIONS USED TO DESIGN THE TRUSSES. IT IS THE BUILDER AND/OR OWNERS RESPONSIBILITY TO SUPPLY ANY/OR ALL INFORMATION IF REQUESTED. BY THE BUILDING DEPARTMENT TO ISSUE BUILDING PERMITS.

ALL ENGINEERED FLOOR SYSTEMS SHALL BE DESIGNED BY THE MANUFACTURER. PROVIDE 2×4 COLLAR TIES @ 4'-0'' ON CENTER FOR ALL RAFTERS.

ALL HEADERS SHALL BE FREE FROM SPLITS, CHECKS & SHAKES.

PROVIDE DOUBLE HEADER JOIST AND TRIMMER AT ALL FLOOR OPENINGS.

PROVIDE DOUBLE JOISTS UNDER ALL PARALLEL PARTITIONS.

PROVIDE I" X 3" "X" BRIDGING @ 8'-0" ON CENTER OR SOLID BLOCKING.

ALL ANGLED WALL TO BE 45 DEGREES UNLESS NOTED OTHERWISE.

ADJUST ALL OVERHANGS OF DIFFERENT PITCHES TO MAINTAIN CONSISTENT LEVEL.

ANY HIP OR VALLEY RAFTER EXCEEDING 28'-O" TO BE L.V.L.

DOUBLE ALL JOISTS AT CANTILEVER LOCATIONS.

ALL EXTERIOR CORNERS SHALL BE BRACED IN EACH DIRECTION WITH PLYWOOD.

IF FOAM SHEATHING IS USED, PROVIDE DIAGONAL LET-IN BRACING.

REPAIR / REPLACE ALL FRAMING DAMAGED BY MECHANICAL SYSTEMS INSTALLATION.

ALL WINDOW HEADERS SHALL BE AT 6' 10 1/2" ABOVE FINISH FLOOR. UNLESS NOTED OTHERWISE.

ALL LUMBER IN CONTACT WITH MASONRY AND/OR CONCRETE SHALL BE PROTECTED FROM DECAY IN ACCORDANCE WITH

PROVIDE 2"/4" CLEAR SPACING BETWEEN MASONRY FIREPLACES AND ALL WOOD FRAMING. PROVIDE FIRESTOPING

BETWEEN FLOOR LEVELS.

ALL SILL PLATES SHALL BE FULL WIDTH OF FOUNDATION WALLS BELOW.

ALL CUTTING, NOTCHING AND BORING SHALL BE DONE IN CONFORMANCE WITH O.R.C. R-602.6 & R-602.6.1

ALL JOISTS, BEAMS AND GIRDERS SHALL BEAR A MINIMUM OF 1 1/2" ON WOOD OR METAL, AND 3" ON MASONRY.

MILLWORK AND CABINET DESIGN SHALL BE BY OTHERS.

WALLS AND PARTITIONS INCLUDING FURRED OR STUDDED OFF SPACES OF MASONRY OR CONCRETE WALLS, AND AT THE

CEILING AND FLOOR OR ROOF LEVELS. FIRESTOPING SHALL BE INSTALLED AT ALL INTERCONNECTIONS BETWEEN VERTICAL AND HORIZONTAL SPACES SUCH AS OCCURRING AT SOFFITS OVER CABINETS, DROP CEILINGS, COVE CEILING, ETC.

IT IS THE RESPONSIBILITY OF THE BUILDER AND/OR OWNER TO VERIFY THAT ALL LUMBER USED FOR THIS PROJECT MEETS THE MINIMUM REQUIREMENTS OF STRENGTH AND MOISTURE CONTENT SET FORTH BY THE STATE AND LOCAL BUILDING CODES.

ALL FRAMING LUMBER SHALL BE DOUGLAS FIR LARCH #2 WITH A MINIMUM MODULUS OF ELASTICITY IF 1,700,000.

ANY MICROLAM (L.V.L.)NOTED ON THESE DRAWINGS MUST MEET THE FOLLOWING DESIGN CRITERIA:

M.O.E. = 1,900,000 psi Fb + 2,600 psi WALL STUDS SHALL BE A MINIMUM OF 2 X 45 @ 16" ON CENTER AND SHALL BE ONE PIECE FULL HEIGHT AND A MINIMUM OF (2) STUDS AT EACH SIDE OF ALL OPENINGS THROUGH ALL WALLS UNLESS NOTED OTHERWISE.

REFER TO THE TYPICAL WALL SECTION FOR SUB-FLOOR AND ROOF SHEATHING THICKNESSES AND MATERIAL TYPES. ALL LUMBER SHALL BE STAMPED WITH THE GRADEMARK OF AN APPROVED TESTING AGENCY.

ALL WINDOW AND DOOR HEADERS TO BE 2 - 2 \times 10 WITH 1/2" SHIM. UNLESS NOTED OTHERWISE.

ALL JACK STUDS SHALL BE BLOCKED BELOW THE DECK.

DOUBLE ALL FLOOR JOISTS AT WHIRLPOOL / BATH LOCATIONS.

ALL PARTITIONS OVER 10'-0" HIGH SHALL BE FRAMED WITH 2 X 6 @ 16" ON CENTER.

PROVIDE 3 - 2 X 4 STRUCTURAL COLUMN @ WOOD BEAM BEARING POINTS.

PROVIDE 3" STEEL COLUMN @ STEEL BEARING POINTS.

PROVIDE 2 X 6 TOP PLATE OF ALL STEEL BEAMS. STAGGER BOLT @ 2'-0" ON CENTER WITH 3/8" BOLTS.

PROVIDE GALVANIZED JOIST HANGERS @ ALL FLUSH BEAMS. INSTALL PER MANUFACTURERS SPECIFICATIONS.

PROVIDE 2 X & STIFFBACKS @ 10'-0" ON CENTER FOR ALL CEILING JOISTS.

CONCRETE NATES

ALL FOOTING CONCRETE SHALL BE 3,000 P.S.I. (28 DAY COMPRESSIVE STRENGTH).

ALL SLABS ON GRADE SHALL BE 4,000 P.S.I. (28 DAY COMPRESSIVE STRENGTH).

PROVIDE CONTROL JOINT @ MIDPOINT OF GARAGE IN BOTH DIRECTIONS.

PROVIDE SAWN OR HAND TROWELED CONTROL JOINTS @ 8'-0" ON CENTER EACH WAY IN DRIVEWAYS.

PROVIDE CONTROL JOINTS IN ALL WALKS EQUAL TO THE WIDTH OF THE WALK.

PROVIDE 6 MILL VAPOR BARRIER UNDER ALL INTERIOR AND GARAGE SLABS.

PROVIDE EXPANSION JOINTS AS REQUIRED BY CODE.

USE AN APPROVED CURING COMPOUND ON ALL FLAT SURFACES

INSULATION NOTES

PROVIDE OPTION FOR ICYNENE INSULATION.

THE USE OF ADMIXTURES IS PROHIBITED.

ALL INSULATION SHALL BE INSTALLED FULL AND THICK IN THE CAVITY PER MANUFACTURERS SPECIFICATIONS.

WALLS: 3 1/2" BATTS (R-15 MINIMUM)

FLAT CEILINGS : 10 1/4" BATTS (R-49 MINIMUM)

VAULTED CEILINGS : 8 1/2" BATTS (R-30 MINIMUM)

BOX ENDS 10 1/4" (R-38 MINIMUM)

SLAB EDGES 2 1/4" RIGID EXTRUDED POLYSTYRENE (R-10 MINIMUM)

PROVIDE VENTILATION BAFFLES AT ALL RAFTER SPACES.

PROVIDE VENTILATION BAFFLES AT ALL RAFTER SPACES.

CAULK ALL OPENINGS IN EXTERIOR WALLS. FOAM ALL OPENINGS IN TOP PLATES.

PROVIDE 2 1/4" THERMADRY STYROFOAM INSULATION ON ALL EXTERIOR FOUNDATION WALLS, FULL DEPTH (R-10 MINIMUM)

ALL PENETRATIONS SHALL BE SEALED WITH BUTYL TAPE.

PROVIDE HOUSE WRAP PER LOCAL CODE.

PROVIDE SEALANTS AT ANY WATER MIGRATION POINTS IN THE CONSTRUCTION.

INSULATION SHALL BE INSTALLED AD ALSO COMPLY WITH ALL MINIMUM ORDINANCES SET FORTH BY THE LOCAL GOVERNING BUILDING AND ZONING DEPARTMENTS. REFER TO THE TYPICAL WALL SECTION FOR R VALUES AND LOCATIONS.

SIEEL NOIES

ALL STRUCTURAL STEEL FOR BEAMS AND PLATES SHALL COMPLY WITH A.S.T.M. SPECIFICATION A-36.

ALL STRUCTURAL STEEL FOR COLUMNS SHALL COMPLY WITH A.S.T.M. SPECIFICATION A-53 GRADE B OR A-501.

ALL REINFORCING STEEL FOR CONCRETE SHALL COMPLY WITH A.S.T.M. SPECIFICATION A0615 GRADE 60.

GYPSUM NOTES

PROVIDE 5/8" REGULAR GYPSUM BOARD THROUGHOUT ENTIRE STRUCTURE EXCEPT AS NOTED.

PROVIDE 5/8" TYPE "X" FIRE CODE GYPSUM BOARD THROUGHOUT GARAGE AND WALLS COMMON TO HOUSE.


PROVIDE WATER RESISTANT GYPSUM BOARD IN ALL BATH & TOILET AREAS.

PROVIDE DUROCK OR EQUAL ON ALL TILED AREAS OF TUB DECK AND SHOWER STALLS.

PROVIDE 5/8" GYPSUM BOARD ON ALL ATTIC ACCESS PANELS.


ALL CEILINGS AND WALLS TO HAVE SMOOTH FINISH.

DESIGN LOADS				
COMPONENT	LIVE LOAD	DEAD LOAD	TOTAL LOAD	
ATTIC (WALK UP STORAGE)	30 P.S.F.	12 P.S.F.	42 P.S.F.	
ATTIC (LIMITED STORAGE)	20 P.S.F.	12 P.S.F.	32 P.S.F.	
ATTIC (NO STORAGE)	10 P.S.F.	12 P.S.F.	22 P.S.F.	
DECKS	40 P.S.F.	12 P.S.F.	52 P.S.F.	
EXTERIOR BALCONIES	60 P.S.F.	12 P.S.F.	72 P.S.F.	
GUARDRAIL AND HANDRAILS	200 P.S.F.	12 P.S.F.	212 P.S.F.	
GUARDRAIL INFILL COMPONENTS	50 P.S.F.	12 P.S.F.	62 P.S.F.	
PASSENGER VEHICLE GARAGES	50 P.S.F.	12 P.S.F.	62 P.S.F.	
ROOMS (OTHER THAN SLEEPING ROOMS)	40 P.S.F.	12 P.S.F.	52 P.S.F.	
SLEEPING ROOMS	30 P.S.F.	12 P.S.F.	42 P.S.F.	
STAIRS	40 P.S.F.	12 P.S.F.	52 P.S.F.	
ROOFS	25 P.S.F.	12 P.S.F.	37 P.S.F.	
SNOW	25 P.S.F.	N/A	25 P.S.F.	
WIND	90 M.P.H.	N/A	90 M.P.H.	
SOLID BEARING	2,000 P.S.F.	N/A	2,000 P.S.F.	

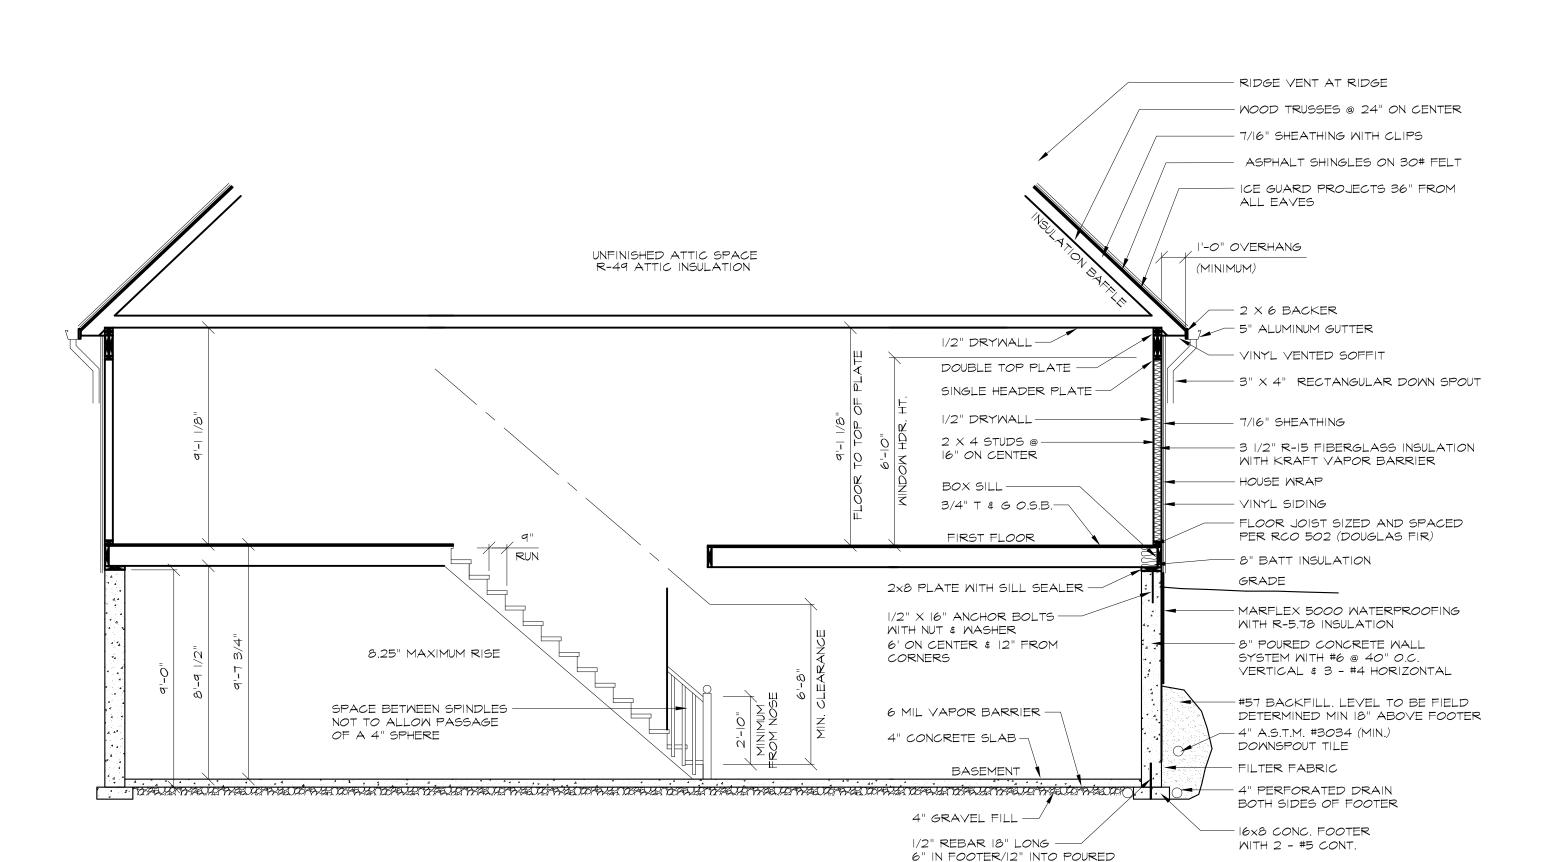


WALL. 12" FROM ALL CORNERS

EXCAVATED AREAS ONLY

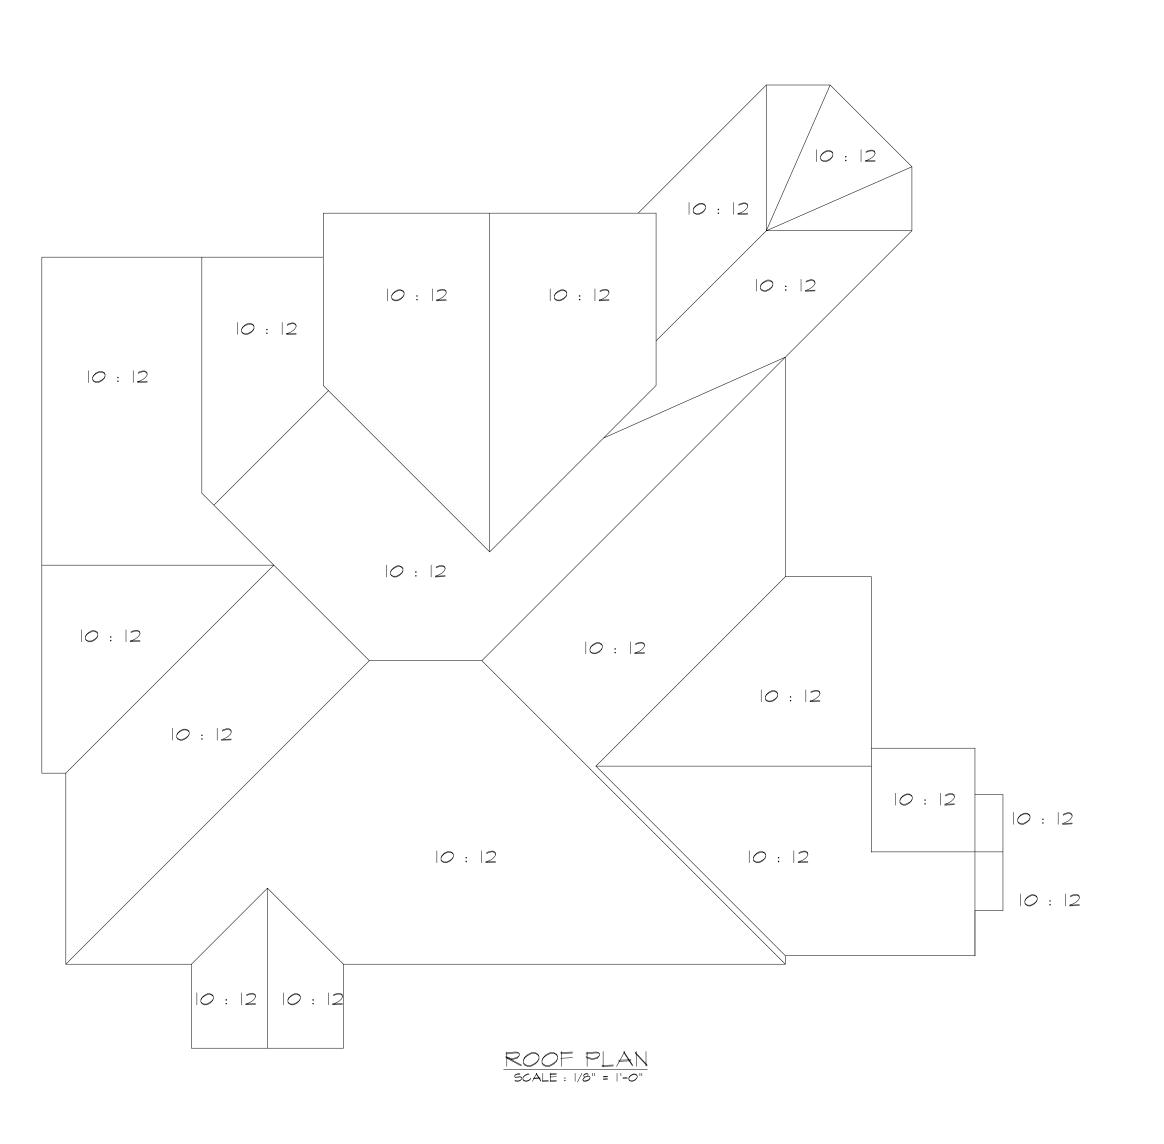




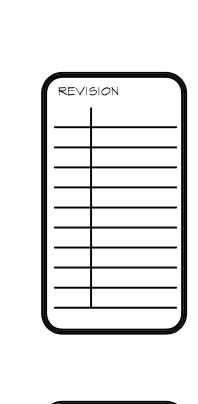




117 CHURCH HILL COURT MOOSTER, OHIO 44691 (330) 464-3369

MOH NAHOON

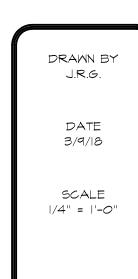


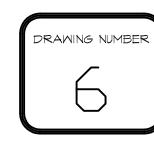

PROPERTY OF MODERN HOME CONCEPTS, ANY
REPRODUCTION WITHOUT WRITTEN PERMISSION
IS PROHIBITED



BRACED WALL METHOD 10.5 FIGURE

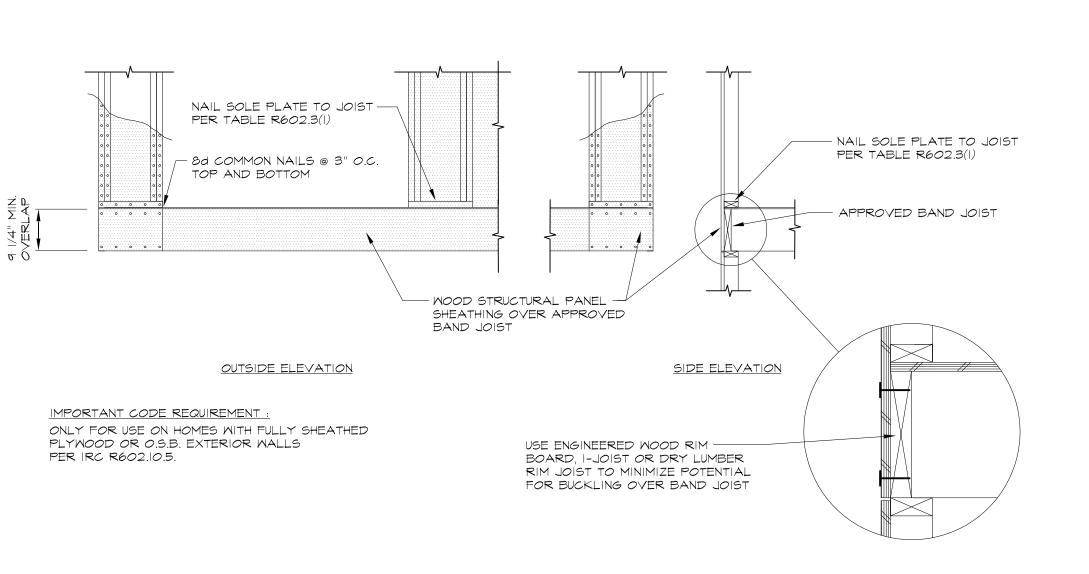

DETAIL I OF 3



MIN 3" X II I/4" NET HEADER ————

FASTEN SHEATHING TO HEADER — WITH 8d COMMON NAILS IN 3"

GRID PATTERN AS SHOWN AND

3" O.C. IN ALL FRAMING (STUDS AND SILLS) (TYP.)

HEADER-TO-JACK-STUD STRAP ON BOTH SIDES OF

MIN. (2) 2" X 4" (TYP.) —

IS NOT REQUIRED

MIN. WIDTH BASED ON 6 : I

HEIGHT - TO - WIDTH RATIO FOR EXAMPLE : 16" MINIMUM FOR 8' HEIGHT

FOUNDATION PER CODE -(TYP.)


ANCHOR BOLT PER R403.1.6 (TYP.)

OPENING (TYP. X INSTALL ON BACKSIDE AS SHOWN ON SIDE

ELEVATION. REF. NO. LSTA24)

IF PANEL SPLICE IS NEEDED
IT SHALL OCCUR WITHIN 24"
OF MID HEIGHT. BLOCKING

1000 lb.----

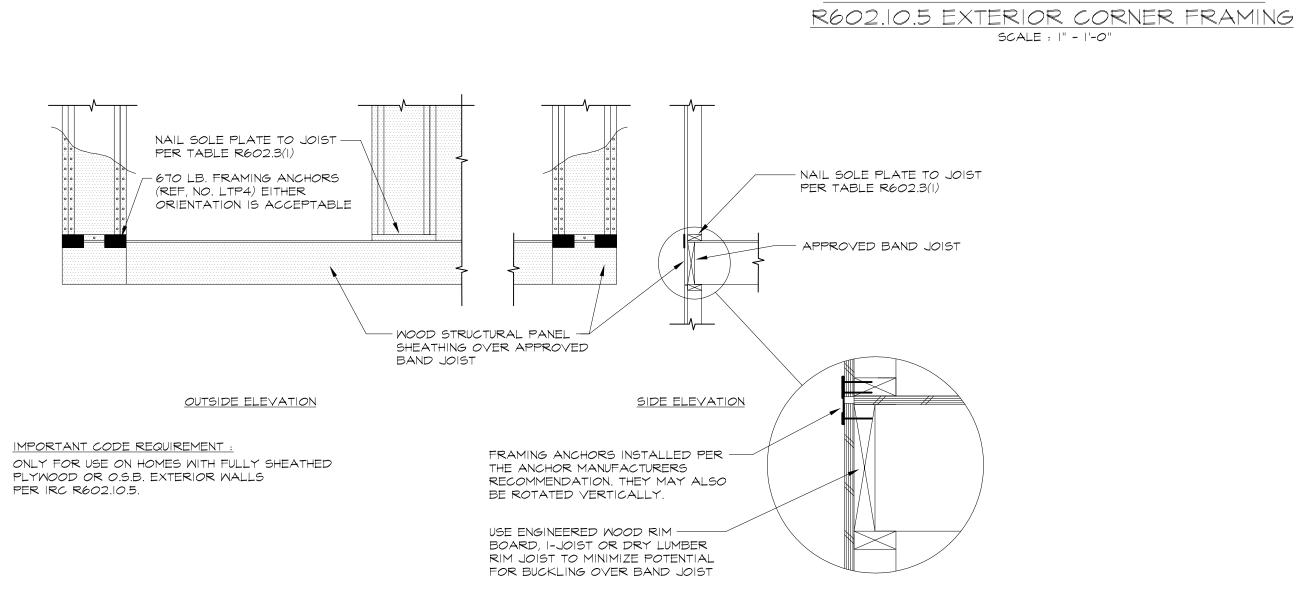


A.P.A. DETAIL OF NARROW WALL BRACING METHOD

WITHOUT HOLD-DOWNS

SCALE: 1/2" - 1'-0"

DETAIL 3 OF 3

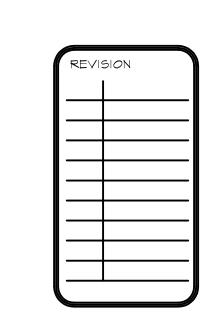

RESIDENTIAL DESIGN & IMAGING INC

CUSTOM HOME DESIGN ADDITIONS CONSULTING

6907 ORCHARD BLVD. PARMA HTS., OHIO 44130 (440) 845-3309



1171 CHURCH HILL COURT MOOSTER, OHIO 44691 (330) 464-3369

DRAWN BY J.R.G. DATE 3/9/18 SCALE 1/4" = 1'-0"

DRAWING NUME

PROPERTY OF MODERN HOME CONCEPTS. ANY REPRODUCTION WITHOUT WRITTEN PERMISSION IS PROHIBITED

3/5/2018 Hudson Maps



Owner Name	Fries Jack	NumOcc	No Addresses Exist in the Master Address List for this Parcel
Legal Description	WESTERN RESERVE RANCH ESTATES PART I LOTS 2-3 ALL PB 45 PGS 97-100	No. Utility Accounts	No Account Information
Parcel ID	3010192	Sewer Provider	NA
Site Address	HUNTINGTON RD	Water Owner	NA
Owner Address	12130 WILSON RD	Electric Provider	NA

7537 Huntington

